

# Camden Local Planning Panel

**Agenda** 

**Electronic Determination** 





## **CAMDEN LOCAL PLANNING PANEL**

# **ELECTRONIC DETERMINATION**

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## **CAMDEN LOCAL PLANNING PANEL**

CLPP01

SUBJECT: DA/2018/710/2 - SECTION 4.55(2) MODIFICATION TO AMEND

DRIVEWAY LOCATION AND ADD ADDITIONAL STOREY TO

APPROVED RESIDENTIAL FLAT BUILDING

**TRIM #:** 20/117129

DA Number:	2018/710/2.	
Development:	Section 4.55(2) modification application to amend the driveway location and add an additional storey to an approved residential flat building.	
Estimated Cost of Development:	\$16,752,000	
Site Address(es):	341 Oran Park Drive, Oran Park LOT: 8 DP: 270899	
Applicant:	Greenfields Development Company C/o Urbanco	
Owner(s):	Perich Property Unit Trust	
Number of Submissions:	Nil	
Development Standard Contravention(s):	24m maximum height of building – 26.8m previously approved, no further encroachments beyond those previously approved are proposed.	
Classification: Local.		
Recommendation:	Approve with modified conditions.	
	Section 4.55(2) of a development previously approved by the Panel.	
Panel Referral Criteria:	Original application referred to the panel for the following criteria:  Development to which SEPP 65 applies; and	
	Departure from Development Standard >10%.	
Report Prepared By:	Clare Aslanis – Executive Planner Team West	

### **PURPOSE OF REPORT**

The purpose of this report is to seek the Camden Local Planning Panel's (the Panel's) determination of a Section 4.55(2) modification application to an approved development application (DA) for a residential flat building at 341 Oran Park Drive, Oran Park.

The Panel is to exercise Council's consent authority functions for this modification as the application is a Section 4.55(2) modification application to a development approved by the Panel.

The original development application (DA/2018/710/1) was referred to the Panel for determination, pursuant to the Minister for Planning's Section 9.1 Direction, as the



development was subject to requirements of State Environmental Planning Policy No. 65 (Design Quality of Residential Apartment Development) and the development proposed a variation to the development standard (maximum height of building) that was greater than 10%.

### **SUMMARY OF RECOMMENDATION**

That the Panel determine DA/2018/710/2 for modifications to an approved residential flat building pursuant to Section 4.16 of the *Environmental Planning and Assessment Act 1979* by granting consent subject to the conditions attached to this report.

### **EXECUTIVE SUMMARY**

Council is in receipt of a modification application for a residential flat building at 341 Oran Park Drive, Oran Park.

The modification application has been assessed against the *Environmental Planning* and Assessment Act 1979, the *Environmental Planning* and Assessment Regulation 2000, relevant environmental planning instruments, development control plans and policies.

The application was publicly exhibited for a period of 14 days in accordance with Camden Development Control Plan 2019. The exhibition period was from 7 January to 27 January 2020 and no submissions were received.

In the current determination the approved development is described as:

"Construction of a 6 storey residential flat building with 48 units, 2 level basement car park, landscaping and associated works."

The subject modification application seeks the following:

- Modification of the apartment layout to provide greater variety in the apartment mix;
- Introduction of two (2) roof top units on the northern side of the building;
- Relocation of the driveway south along Fordham Way to enhance streetscape presentation and ground floor unit amenity;
- Relocation of the rooftop communal space to the southern side of the roof;
- Minor amendments to basement parking arrangements;
- Modification of landscape plans to reflect amended architectural details;
- Relocation of the temporary bin holding area to be integrated with the building's architecture: and
- The total number of units has increased from 48 units to 53 units.

In determining the original development application, the Panel supported a contravention to the maximum height of buildings development standard. State Environmental Planning Policy (Sydney Region Growth Centre) 2006 prescribes a maximum building height of 24 metres for the site. The currently approved development has a maximum building height of 26.8 metres (including the lift overrun). The changes proposed as part of the subject modification application do not alter the maximum overall height of the approved development (which remains at 26.8 metres).

Based on the assessment, it is recommended that the modification application be approved subject to the conditions attached to this report.



### KEY PLANNING CONTROL VARIATIONS

Control	Approved	Proposed
Maximum Height of Buildings 24m (SEPP)	26.8m	26.8m (unchanged)
Minimum 25% Communal Open Space (ADG)	420m² (22%)	313m² (16%)
4 storey building envelope.	6 storeys	7 storeys

### **AERIAL PHOTO**



Figure 1: Aerial image with subject site shaded green.

### **THE SITE**

The site is commonly known as 341 Oran Park Drive, Oran Park and is legally described as Lot 8, DP 270899 (also known as the Tranche 8 development area). The site is rectangular in shape and is located within a street block bounded by Podium Way, Oran Park Drive and Peter Brock Drive. The site is predominantly vacant with the exception of an at grade car park and a recently constructed six (6) storey commercial building ('Commercial Building 1').

Directly to the west is a proposed community facility, beyond which lies a riparian corridor. To the north is vacant land which is a potential site for the future Oran Park Railway Station. To the south and across Oran Park Drive the area predominately consists of low density residential development. To the east across Oran Park Drive is the Oran Park 'Podium' Shopping Centre.



### **ZONING PLAN**



Figure 2: Zoning map with subject site shaded green.



### **AREA MASTER PLAN**



Figure 3: Structure Plan from Oran Park DCP. The subject site is located in the mixed use zone (Immediately to the left of the 'u' in use in the south-western corner of the plan)

### **THE PROPOSAL**

DA/2018/710/1 granted approval for a six storey residential flat building. Specifically, the approved development involves:

- Construction of a residential flat building containing:
  - a. 48 units across 6 levels;
    - i. 1 x studio;
    - ii.9 x 1 bedroom;
    - iii. 30 x 2 bedroom;
    - iv. 8 x 3 bedroom;
  - b. 2 levels of basement car parking with 68 car parking spaces;
  - c. A communal rooftop terrace;
  - d. Associated drainage works; and
  - e. Associated landscaping works.

The subject Section 4.55(2) modification application (DA/2018/710/2) effectively seeks approval to add an additional storey to the approved development and make other associated changes to the approved development.

The development as modified will result in the following:

- Construction of a residential flat building containing:
  - a. 53 units across 7 levels;
    - i. 14 x 1 bedroom;
    - ii. 29 x 2 bedroom;
    - iii. 10 x 3 bedroom;
  - b. 2 levels of basement car parking with 73 car parking spaces;



- c. A communal rooftop terrace at the same level as the top floor units;
- d. Associated drainage works; and
- e. Associated landscaping works.

### **ASSESSMENT**

### Environmental Planning and Assessment Act 1979 - Section 4.55

### (2) Other Modifications

A consent authority may, on application being made by the applicant or any other person entitled to act on a consent granted by the consent authority and subject to and in accordance with the regulations, modify the consent if -

(a) it is satisfied that the development to which the consent as modified relates is substantially the same development as the development for which consent was originally granted and before that consent as originally granted was modified (if at all), and

The development to which the consent as modified relates is substantially the same as the development for which consent was originally granted and before that consent as originally granted was modified. The application is for a residential flat building and remains similar in appearance as modified.

(b) it has consulted with the relevant Minister, public authority or approval body in respect of a condition imposed as a requirement of a concurrence to the consent or in accordance with the general terms of an approval proposed to be granted by the approval body and that Minister, authority or body has not, within 21 days after being consulted, objected to the modification of that consent, and

There were no General Terms of Approval issued for the approved development.

- (c) it has notified the application in accordance with—
  - (i) the regulations, if the regulations so require, or
  - (ii) a development control plan, if the consent authority is a council that has made a development control plan that requires the notification or advertising of applications for modification of a development consent,

The application was publicly exhibited in accordance with the *Environmental Planning* and Assessment Regulation 2000 and Camden Development Control Plan 2019.

(d) it has considered any submissions made concerning the proposed modification within the period prescribed by the regulations or provided by the development control plan, as the case may be.

No submissions were received.

(3) In determining an application for modification of a consent under this section, the consent authority must take into consideration such of the matters referred to in section 4.15(1) as are of relevance to the development the subject of the application. The consent authority must also take into



### consideration the reasons given by the consent authority for the grant of the consent that is sought to be modified.

An assessment against Section 4.15(1) of the Environmental Planning and Assessment Act 1979 is provided below.

### Environmental Planning and Assessment Act 1979 – Section 4.15(1)

In determining an application, the consent authority is to take into consideration such of the following matters as are of relevance to the development:

### (a)(i) the provisions of any environmental planning instrument

The environmental planning instruments that apply to the development are:

- State Environmental Planning Policy No 65 Design Quality of Residential Apartment Development and Apartment Design Guide.
- State Environmental Planning Policy (Sydney Region Growth Centres) 2006.
- State Environmental Planning Policy (Building Sustainability Index: BASIX) 2004.
- State Environmental Planning Policy No 55 Remediation of Land.
- Sydney Regional Environmental Plan No 20 Hawkesbury-Nepean River.

# <u>State Environmental Planning Policy No 65 - Design Quality of Residential Apartment</u> Development and the Apartment Design Guide

The development is subject to the requirements of State Environmental Planning Policy No. 65 – Design Quality of Residential Apartment Development (SEPP 65) and the Apartment Design Guide (ADG).

A statement from a qualified Architect was submitted with the application verifying that they designed the development as modified. The statement also provides an explanation that verifies how the design quality principles are achieved within the development and demonstrates, in terms of the Apartment Design Guide (ADG), how the objectives in Parts 3 and 4 of the guide have been upheld.

The ADG contains objectives, design criteria and design guidelines for residential apartment development. In accordance with Clause 6A of the SEPP the requirements contained within a DCP relating to visual privacy, solar and daylight access, common circulation and spaces, apartment sizes and layout, ceiling heights, private open space and balconies, natural ventilation and storage have no effect. In this regard objectives, design criteria and design guidelines set out in Parts 3 and 4 of the ADG prevail.

An assessment table in which the proposed development is considered against SEPP 65 and the ADG is provided as an attachment to this report.

The development is generally acceptable having regard to the 9 design quality principles contained in the SEPP and where the proposed development varies from the design criteria stipulated in the ADG further discussion is provided below.



### Communal Open Space

Objective 3D-1 of the ADG requires communal open space to have a minimum area equal to 25% of the site.

The communal open space provided as part of the currently approved development is 420sqm in area equating to 22% of the site. The communal open space provided as part of the modified development is 313sqm in area equating to 16% of the site.

As part of the modification application there is an increase in the number of residential units to be provided on the site (53 units are proposed, while 48 units are approved). Two (2) additional units are proposed on the upper level with the rooftop communal open space relocated to the southern side of the roof and reduced in size by 13sqm (144sqm proposed in lieu of 157sqm as currently approved).

At ground level there has also been a reduction in the communal open space due to the realignment of the driveway and basement entry. The stairs to Julia Creek have also been reconfigured, which has also resulted in a minor reduction of communal open space.

Whilst there is a further departure from the minimum area recommended by the Apartment Design Guide, the proposal remains compliant with the minimum (15%) required by the Oran Park DCP. The spaces proposed provide for a range of uses by residents with more passive areas at ground level and gathering spaces on the rooftop.



Figure 4: Approved ground floor plan with communal area shown.





Figure 5: Proposed ground floor plan with reconfigured communal area, driveway and temporary holding area for waste bin collection shown.

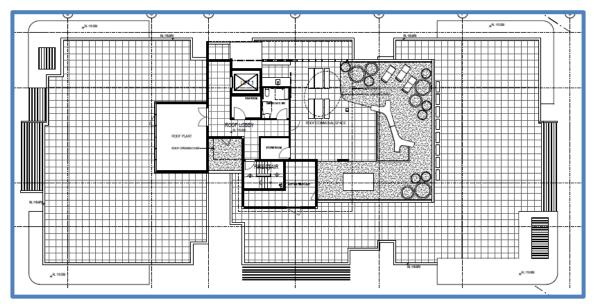


Figure 6: Approved rooftop common area





Figure 7: Proposed reconfigured rooftop communal area with additional penthouse units.

It is also noted that the proposal is adjacent to the Julia Creek reserve where high quality open spaces are already provided within the public domain.

Whilst not meeting the design criteria, it is assessed that area of communal open space proposed is adequate and ensures high levels of residential amenity and satisfactory opportunities for landscaping.

The level of communal open space is considered reasonable given the location of the site within the Oran Park Town Centre and given the high quality public open spaces that surround the site.

<u>State Environmental Planning Policy (Sydney Region Growth Centres) 2006 - (Growth Centres SEPP)</u>

An assessment table in which the proposed development is considered against the Growth Centres SEPP is provided as an attachment to this report.

As noted in the assessment table, the development as modified has a maximum building height of 26.8 metres which equates to a 2.8 metre (11.7%) contravention to the maximum height of buildings development standard prescribed under the SEPP (24 metres).

As previously indicated, the Panel considered and supported a Clause 4.6 written request for the contravention to the maximum height of buildings development standard when approving the original development application. The contravention was limited to the encroachment of the lift overrun beyond the maximum building height plane.

The overall height of the lift overrun remains unchanged as part of the modification application and the additional units on the upper level are contained within the maximum height of buildings development standard for the site (i.e. no further encroachment/contravention is sought).





Figure 8: Building Height Planes showing no additional encroachment into 24m maximum building height.

### State Environmental Planning Policy (Building Sustainability Index: BASIX) 2004

An updated BASIX Certificate was submitted with the application indicating that the proposal remains fully compliant with the BASIX requirements. The recommended modified conditions ensure the amended BASIX Certificate commitments are implemented into the development.

### State Environmental Planning Policy No 55 - Remediation of Land (SEPP 55)

SEPP 55 requires the consent authority to be satisfied that the site is suitable for its intended use (in terms of contamination) prior to granting consent. The modifications do not result in any departure from the provisions of this plan.

### Sydney Regional Environmental Plan No 20 - Hawkesbury-Nepean River (SREP 20)

The proposed development (as modified) remains consistent with the aim of SREP 20 (to protect the environment of the Hawkesbury-Nepean River system) and all of its planning controls. There will be no detrimental impacts upon the Hawkesbury-Nepean River system as a result of the modified development.

(a)(ii) the provisions of any proposed instrument that is or has been the subject of public consultation under this Act and that has been notified to the consent authority (unless the Secretary has notified the consent authority that the making of the proposed instrument has been deferred indefinitely or has not been approved)



### **Draft Environment SEPP**

The development remains consistent with the Draft Environment SEPP in that there will be no detrimental impacts upon the Hawkesbury-Nepean River system as a result of the development.

### (a)(iii) the provisions of any development control plan

### Camden Development Control Plan 2011 (Camden DCP)

An assessment table in which the proposed development is considered against the Camden DCP is provided as an attachment to this report.

### Oran Park Development Control Plan 2007 (Oran Park DCP)

An assessment table in which the proposed development is considered against the Oran Park DCP is provided as an attachment to this report. An assessment of the variation sought (indicative building envelope plan) is provided below.

### Proposed Variation No 1 – Building Envelope

The proposed development seeks a variation to the 4 storey building envelope control contained in Control 1 in Section 7.3 of Part B1 Oran Park Town Centre of the Oran Park DCP:

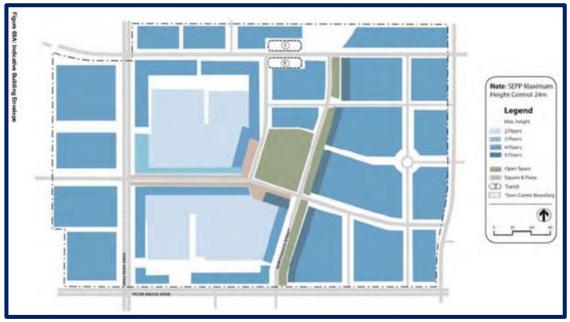


Figure 9: Indicative Building Envelope Plan from the Oran Park DCP.

The objectives for the building envelope control are:

- To ensure that the bulk and scale of future development responds to the desired vision, scale and character of the Oran Park Town Centre and surrounding development.
- To encourage a variety of building heights within the Town Centre which respond to the site specific design considerations.
- To embody buildings with flexibility in their use over time.



In accordance with clause 4.15(3A)(b) of the Environmental Planning and Assessment Act 1979 there must be flexibility in the application of DCP provisions to allow reasonable alternative solutions that achieve the relevant objectives.

It is considered that the proposed development remains consistent with the objectives of the control given that:

- The additional floor (7<sup>th</sup>) floor proposed as part of the subject modification application is contained within the maximum height of buildings development standard (24m) prescribed for the site;
- The proposed development compares favourably to the adjacent six (6) storey commercial building (Commercial Building 1) which was approved by the Sydney Western City Planning Panel (SWCPP) and which has a maximum building height of 28.15m;
- The proposed development compares favourably to the six (6) storey commercial building (*Commercial Building 2*) proposed as part of DA/2019/269/1 (which is to be located directly to the south *Commercial Building 1*) which has a maximum building height of 28.85m. At the time of writing this report that application is being considered by the SWCPP for electronic determination (with a recommendation for approval);
- The proposed building scale would result in the introduction of additional variety in building heights within the town centre. The existing building heights within the town centre are:
  - Commercial 1 Building 6 storeys.
  - Commercial 2 Building 6 storeys.
  - Stage 1 of the retail component 4 storeys at the street frontage.
  - Oran Park Sales building 2 storeys with a 4 storey clock tower.
  - Camden Council Administration Building 3 storeys
  - o Oran Park Library 2 storeys.
- The proposed development is considered to respond to the site-specific design considerations, most prominently is the development's concentration of scale in close proximity to the recently announced Oran Park train station indicative location.

Consequently, it is recommended that the panel support this variation to the minimum building envelope.

# (a)(iiia) the provisions of any planning agreement that has been entered into under section 7.4, or any draft planning agreement that a developer has offered to enter into under section 7.4

The site falls within land which is subject to the Oran Park Urban Release Area Voluntary Planning Agreement (VPA), signed in September 2011.

The Oran Park VPA provides for infrastructure and associated facilities within the Oran Park Town in lieu of payments under the Oran Park & Turner Road Precinct Section 94 Contributions Plan.

Conditions of consent were previously implemented and remain unchanged by the modification as applicable contributions and deliverables triggers are determined on the basis of net developable area and residential lots.



# (a)(iv) the regulations (to the extent that they prescribe matters for the purposes of this paragraph)

The *Environmental Planning and Assessment Regulation 2000* prescribes several matters that are addressed in the conditions attached to this report.

### (b) the likely impacts of the development, including environmental impacts on both the natural and built environments, and social and economic impacts in the locality

As demonstrated by the above assessment, the development as modified is unlikely to have a significant negative impact on either the natural or built environments, or the social and economic conditions in the locality.

### (c) the suitability of the site for the development

As demonstrated by the above assessment, the site is considered to be suitable for the development.

### (d) any submissions made in accordance with this Act or the regulations

The modification application was publicly exhibited for a period of 14 days in accordance with Camden Development Control Plan 2011. The exhibition period was from 7 January to 27 January 2020 and no submissions were received.

### (e) the public interest

The public interest is served through the detailed assessment of this application under the *Environmental Planning and Assessment Act 1979*, the *Environmental Planning and Assessment Regulation 2000*, environmental planning instruments, development control plans and policies. Based on the above assessment, the development is consistent with the public interest.

Council has considered the reasons given by the consent authority for the grant of the consent that is sought to be modified.

### **EXTERNAL REFERRALS**

No external referrals were required for this application.

### FINANCIAL IMPLICATIONS

This matter has no direct financial implications for Council.

### CONCLUSION

The modification application has been assessed in accordance with Sections 4.15(1) and 4.55(2) of the *Environmental Planning and Assessment Act 1979* and all relevant instruments, plans and policies. The application is recommended for approval subject to the conditions attached to this report.



### **RECOMMENDED**

That the Panel approve DA/2018/710/2 for the modification of an approved residential flat building at 341 Oran Park Drive, ORAN PARK subject to the modified conditions attached to this report.

### **REASONS FOR DETERMINATION**

- The Camden Local Planning Panel is satisfied that the proposed modification is of minimal environmental impact and is substantially the same development as the development for which the consent was originally granted.
- 2. The development, as modified, is consistent with the objectives of the applicable environmental planning instruments, being State Environmental Planning Policy (Sydney Region Growth Centres) 2006; State Environmental Planning Policy No 55 Remediation of Land; State Environmental Planning Policy (Building Sustainability Index: BASIX) 2004; and Sydney Regional Environmental Plan No 20 Hawkesbury-Nepean River.
- 3. The development, as modified, is consistent with the objectives of the applicable development control plans, being the Oran Park Precinct Development Control Plan 2007 and Camden Development Control Plan 2019.
- 4. The development, as modified, is considered to be of an appropriate scale and form for the site and the character of the locality.
- 5. The development, as modified, is unlikely to have any unreasonable adverse impacts upon the natural or built environment.

#### **ATTACHMENTS**

- 1. Attachment 1 Apartment Design Guide Assessment Table
- 2. Attachment 2 Growth SEPP Assessment Table
- 3. Attachment 3 DCP Assessment Tables
- 4. Attachment 4 Recommended Modified Conditions
- 5. Attachment 5 Proposed Plans
- 6. Attachment 6 Approved Stamped Plans
- 7. Attachment 7 Proposed Plans Internal Supporting Document
- 8. Attachment 8 Approved Stamped Plans Internal Supporting Document

Control	Proposed	Compliance
3C-1 Public Domain Interface - Transition between private and public domain is achieved without compromising safety and security.	Ground level apartments as amended are elevated to provide surveillance and improve visual privacy. Landscape buffers are used in some instance to further improve privacy.	Yes
3D-1 Communal and Public Open Space - An adequate area of communal open space is provided to enhance residential amenity and to provide opportunities for landscaping.	The communal open space provided as part of the currently approved development is 420sqm in area equating to 22% of the site. The communal open space provided as part of the modified development is 313sqm in area equating to 16% of the site. Whilst there is a further departure from the minimum area recommended by the Apartment Design Guide, the proposal remains compliant with the minimum (15%) required by the Oran Park DCP. Furthermore, a variety of different communal open spaces are provided which is conducive to various activities. Additionally the site has direct access to the Julia Creek Riparian Corridor and public recreation space areas within Julia Reserve Skate Park.	No, see further discussion in main body of report.
3D-2 Communal and Public Open Space  Communal open space is designed to allow for a range of activities, respond to site conditions and be attractive and inviting.	The modified proposal retains two separate areas (at ground level and on the rooftop) to promote different uses of the spaces. The areas of communal open space are appropriately designed to allow for a range of activities.	Yes
3D-3 Communal and Public Open Space  Communal open space is designed to maximise safety.	Street level communal areas remain visible from the living rooms and balconies of the southern apartments. The modified plans provide units to the roof area, allowing for improved surveillance from the lift foyer. The rooftop communal area can be accessed by secured lifts and stairs by all residents.	Yes
3E-1 Deep Soil Zones - Design Criteria  Site area > 1,500m²  Minimum dimensions of 6m and 7% of site area.	Provision of deep soil area has been retained in modified designed. The basement does not encroach on this area.  8.44% of site with minimum 6m dimension is achieved.	Yes
3G-3 Pedestrian Access and Entries  Large sites provide pedestrian links for access to streets and	The retained street level communal space acts as through site link to Julia Creek.	Yes

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connection to destinations.		
3H-1 Vehicle Access  Vehicle access points are designed and located to achieve safety, minimise conflicts between pedestrians and vehicles and create high quality streetscapes.	The vehicular access has been relocated and no longer traverses the front of the site but rather provides access via the side of the building. The modified layout provides for a significantly improved streetscape and reduces conflicts with pedestrians.	Yes
3J-1 Bicycle and Car Parking - Design Criteria	The modified proposal complies with Council's minimum DCP car parking rates for residential flat buildings.	Yes
For development in the following locations:	_	
<ul> <li>on sites that are within 800m of a railway station or light rail stop in the Sydney Metropolitan Area, or</li> <li>on land zoned, and sites</li> </ul>		
within 400m of land zoned, B3 Commercial Core, B4 Mixed Use or equivalent in a nominated regional centre.		
the minimum car parking requirement for residents and visitors is set out in the Guide to Traffic Generating Developments, or the car parking requirement prescribed by the relevant council, whichever less.		
3J-4 Bicycle and Car Parking  Visual and environmental impacts	The new car park entry reduces the visual impacts by reducing the space occupied by driveway within the front setback.	Yes
of underground car parking are minimised.		
4A-1 Solar and Daylight Access - Design Criteria	Complies.	Yes
Living rooms and private open spaces of at least 70% of apartments in a building receive a minimum of two hours direct sunlight between 9am and 3pm at mid-winter in the Sydney Metropolitan Area and in the Newcastle and Wollongong local government areas.  A maximum of 15% of apartments in a building receive no direct sunlight between 9am and 3pm at mid-winter.	90% of apartments are able to achieve minimum solar access requirements.	
4B-1 Natural Ventilation	Complies.	Yes

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All habitable rooms are naturally ventilated.		
4B-3 Natural Ventilation - Design Criteria	The number of corner apartments with dual aspect is maximised to achieve ADG compliance.	Yes
At least 60% of apartments are naturally cross ventilated in the first nine storeys of the building. Apartments at ten storeys or greater are deemed to be naturally ventilated only if any enclosure of the balconies at these levels allows adequate natural ventilation and cannot be fully enclosed.	69.8% of apartments achieve natural cross ventilation.	
4D-1 Apartment Size and Layout - Design Criteria	All minimum areas are achieved for the various unit types within the proposal.	Yes
Apartments are required to have the following minimum internal areas:  Studio 35m².  One bedroom 50m².  Two bedroom 70m².  Three bedroom 90m².		
Every habitable room must have a window in an external wall with a total minimum glass area of not less than 10% of the floor area of the room. Daylight and air may not be borrowed from other rooms.		
4D-2 Apartment Size and Layout - Design Criteria	Complies in all units.	Yes
Habitable room depths are limited to a maximum of 2.5 x the ceiling height.		
In open plan layout (where the living, dining and kitchen are combined) the maximum habitable room depth is 8m from a window.		

4D-3 Apartment Size and Layout	Complies.	Yes
Apartment layouts are designed to accommodate a variety of household activities and needs.		
4E-1 Private Open Space and Balconies - Design Criteria	All units comply with relevant minimum balcony area.	Yes
All apartments are required to have primary balconies as follows:  Studio apartments 4m².		
One bedroom apartments 8m² with a minimum depth of 2m. Two bedroom apartments 10m² with a minimum depth of 2m. Three+ bedroom apartments		
12m² with a minimum depth of 2.4m.  For apartments at ground level or on a podium or similar structure, a private open space is provided instead of a balcony. It must have a minimum area of 15m² and a minimum depth of 3m.		
4E-3 Private Open Space and Balconies	Complies.	Yes
Private open space and balcony design is integrated into and contributes to the overall architectural form and detail of the building.		
4K-1 Apartment Mix	Provided: 14 x one bedroom	Yes
A range of apartment types and sizes is provided to cater for different household types now and into the future.	29 x two bedroom 10 x three bedroom	
4K-2 Apartment Mix	A range of units is provided on each level of the development.	Yes
The apartment mix is distributed to suitable locations within the building.		
4N-1 Roof Design  Roof treatments are integrated into the building designed and	Plant equipment is setback from the edges of the building to ensure that it is not visible from the ground. All plant equipment will be appropriately screened.	Yes

positive respond to the streets.		
·	7 - 1 - 1 - 1 - 1 1 1	
4Q-1 Universal Design	7 adaptable apartment units are proposed.	Yes
Universal design features are included in apartment design to promote flexible housing for all community members.		
4Q-2 Universal Design  A variety of apartments with adaptable designed are provided.	Adaptable units include one, two and three bedroom options and are on different levels of the building.	Yes
4Q-3 Universal Design	Living/dining room layouts are flexible. Studies could have other uses such as	Yes
Apartment layouts are flexible and accommodate a range of lifestyle needs.	storage.	
4W-1 Waste Management  Waste storage facilities are designed to minimise impacts on the streetscape, building entry and amenity of residents.	The waste storage area in the basement are will not be visible from the street. The bin holding area has been modified to integrated with the building as it is visible from the street.	Yes

CLPP01

# State Environmental Planning Policy (Sydney Region Growth Centres) 2006 (Growth SEPP) <u>Assessment Table</u>

Control	Proposed	Compliance
Appendix 1, 4.3 Height of Buildings - Maximum building height of 24m above finished ground level	The development as modified has a maximum building height of 26.8m above finished ground level. The maximum building height remains unchanged as part of this modification application	No, contravention previously supported as part of original DA. No additional height breach proposed as part of this modification application.
Appendix 1, 6.1 Public Utility Infrastructure - The consent authority is to be satisfied that essential public utility infrastructure is available or that adequate arrangements have been made to make that infrastructure available when required	A standard condition is recommended to ensure that essential public utility infrastructure will be provided when required	Yes, previously conditioned.
Appendix 1, 6.6 Development in Special Areas - Development consent is not to be granted for development within a special area unless a development control plan that provides for detailed development controls has been prepared for the land	The Oran Park Development Control Plan 2007 applies to the site and Part B1 of that development control plan specifies detailed development controls for the Oran Park Town Centre in which this site is located.	Yes.

### Camden Development Control Plan 2019

Control			Proposed	Compliance
1.2.2	Notification	of	The application was publicly	Yes
Application	ons - Applications are	to	exhibited in accordance with	
be pul	olicly exhibited	in	the Camden DCP. No	
accordance	e with the Camd	en	submissions were received.	
DCP				

Oran Park Development Control Plan 2007

·	Oran Park Development Control Plan 2007			
Control	Proposed	Compliance		
6.9 Acoustics - All industrial / commercial / employment development is to comply with the Industrial Noise Policy (DECC 2000).	The detailed acoustic report by Acoustic Logic lodged with the original development application remains relevant for the modified proposal.	Yes.		
8.3 Waste Management - Development must demonstrate that the design takes into account refuse storage and collection without reducing the amenity of a dwelling or neighbouring lots.	The dedicated waste area is fully enclosed and will not impact on the amenity of adjoining development. Waste collection occurs from a temporary holding area within the front of the building.	Yes.		
<b>8.4 Site Facilities and Servicing</b> - Garbage, mailbox structures, service meters and the like are to be integrated with the overall design of buildings and/or landscaping.	Facilities and servicing requirements are integrated within the landscape design of the proposal.	Yes.		
8.6 Safety and Surveillance - Buildings should be designed to overlook streets, lanes and other public or communal areas to provide casual surveillance. In the case of comer lots habitable windows are also be oriented to overlook the side street.	The building has been designed to provide casual surveillance of surrounding streetscape areas from all levels. The modifications to ground floor units improves the opportunities for further casual surveillance.	Yes.		
Developments are to avoid creating areas for concealment and blank walls facing the street.	The modified design has reduced the length of blank walls.	Yes.		
Part B: Site Specific DCP				
5.1 Public Domain - Public domain areas are to be designed and located generally in accordance with Figure 67. The design of public domain areas shall take into consideration the Public Domain Manual adopted by Camden Council (Attachment A).	The modified landscape design has been prepared consistent with the Public Domain Manual.	Yes, reinforced by existing conditions of consent.		

5.3 Street Trees - Street trees and open space planting is to provide generous shade for pedestrians in summer and allow for sunlight penetration to street level in winter.	The modified landscape design has been prepared consistent with the Public Domain Manual. Species selected allow for shade in summer and sunlight penetration in summer.	Yes, reinforced by existing conditions of consent.
7.3 Building Envelopes / Bulk & Scale - Building heights are to be in accordance with the Building Envelope Plan shown in Figure 69A.	The proposed development exceeds the maximum height of building development standard prescribed under the SEPP (26.8m in lieu of 24m standard) and varies from the indicative building envelope identified in the DCP (7 storeys in lieu of 4 storeys)	No, contravention previously supported as part of original DA. Refer to additional discussion in main body of report.
Minimum ceiling heights are detailed in in the table below. For the purposes of this control 'ceiling height' is measured internally from finished floor level to ceiling level.  Residential floors - 2.7m	Minimum Floor to ceiling Height = 2.7m	Yes.

7.5 Weather Protection - Weather protection must maintain a feeling of openness and enhance both the public function of the specific space and /or street.	Weather protection has been provided for the building itself at entrances and key areas.	Yes.
Buildings are to maximise areas of street activation through a mixture of ground floor retail/commercial suites and the incorporation of ground floor terrace areas along the street frontage in residential	Ground floor terraced landscape area to ensure activated street frontages.	Yes.
frontage in residential development.  No external security shutters to be permitted.	No external security shutters are proposed.	Yes.

Page 3

7.8 Solar Access - Any Development Application for the construction of buildings is required to submit detailed solar access diagrams for between 9am and 3pm mid-winter to demonstrate sufficient solar access is maintained to public and private spaces and streets	Solar access diagrams demonstrate that the proposal maintains adequate solar access to streetscape areas.	Yes.
8.1 Vehicle Parking and Storage – Above ground parking is not encouraged without appropriate design measures to mitigate adverse visual impacts.	No above ground parking is proposed.	Yes.
Bicycle racks/storage areas are to be provided in all developments in accordance with the following requirements.  • residential development = 1 space per 4 apartments.	The proposal includes a total of 18 lockable bicycle storage spaces in basement 1 of the building, exceeding the DCP requirements (of 14).	Yes.
Section 7.7.4 Key Controls Table	(Table 23) - B1, B2, B3 and B4	zones
Communal open space - 15% of site area. This control is able to be varied where the applicant demonstrates the development has good access to public open space or where the area of private open space is more than the minimum specified below.	The proposal delivers a total of 313m² of common open space, representing 16% of the site.	Yes.
Front Setback - Residential flat buildings: 4.5m to building façade line Shop top housing: Om for first floor 4m for floors above first floor	4.5m building line setback provided to roadway frontages	Yes.
Car parking spaces - 1 space per dwelling, plus 0.5 spaces per 3 or more bedroom dwelling.	Residential Spaces required = 58 Residential Spaces provided = 62	Yes, reinforced by conditions of consent.
Car parking spaces to be located below ground or behind the building  1 visitor car parking space per 5 apartments (may be above	Visitor paces required = 11 Visitor paces provided = 10 (plus one electric vehicle charging bay)  Bicycle required = 17.5	
ground)  Bicycle parking spaces: 1 per 3 dwellings	Bicycle required = 18	

### **MODIFIED CONSENT**

(i) The description of the development is to be modified to read:

Construction of a 7 storey Residential flat building with 53 units and 2 levels of basement car parking, rooftop terrace, landscaping, stormwater drainage, earthworks and associated civil works.

- (ii) Conditions 1.0(1) and 1.0(2) are to be modified to read as follows:
- 1.0(1) Approved Plans and Documents Development shall be carried out in accordance with the following plans and documentation, and all recommendations made therein, except where amended by the conditions of this development consent:

Plan Reference/ Drawing No.	Name of Plan	Prepared by	Date
DA1001 Issue 10	Site Plan	Allen Jack and Cottier	25 February 2020
DA1002 Issue 10	Site Calculations	Allen Jack and Cottier	25 February 2020
DA2001 Issue 12	Basement 2 Plan	Allen Jack and Cottier	25 February 2020
DA2002 Issue 13	Basement 1 Plan	Allen Jack and Cottier	25 February 2020
DA2101 Issue 14	Ground Floor Plan	Allen Jack and Cottier	25 February 2020
DA2102 Issue 13	Levels 1 and 2 Floor Plan	Allen Jack and Cottier	25 February 2020
DA2103 Issue 13	Levels 3 and 4 Floor Plan	Allen Jack and Cottier	25 February 2020
DA2104 Issue 13	Levels 5 and 6 Floor Plan	Allen Jack and Cottier	25 February 2020
DA2106 Issue 12	Roof Plan	Allen Jack and Cottier	25 February 2020
DA3101 Issue 13	Elevations 1 Plan	Allen Jack and Cottier	25 February 2020
DA3102 Issue 13	Elevations 2 Plan	Allen Jack and Cottier	25 February 2020
DA3201 Issue 11	Sections Plan	Allen Jack and Cottier	25 February 2020
L01 to L11 Issue A	Landscape Plans	JMD Design	29 November 2019

18188_CC_BE01	Engineering Plans	Henry and	4 February
18188_CC_SE02		Hyams	2020
Revision 4			

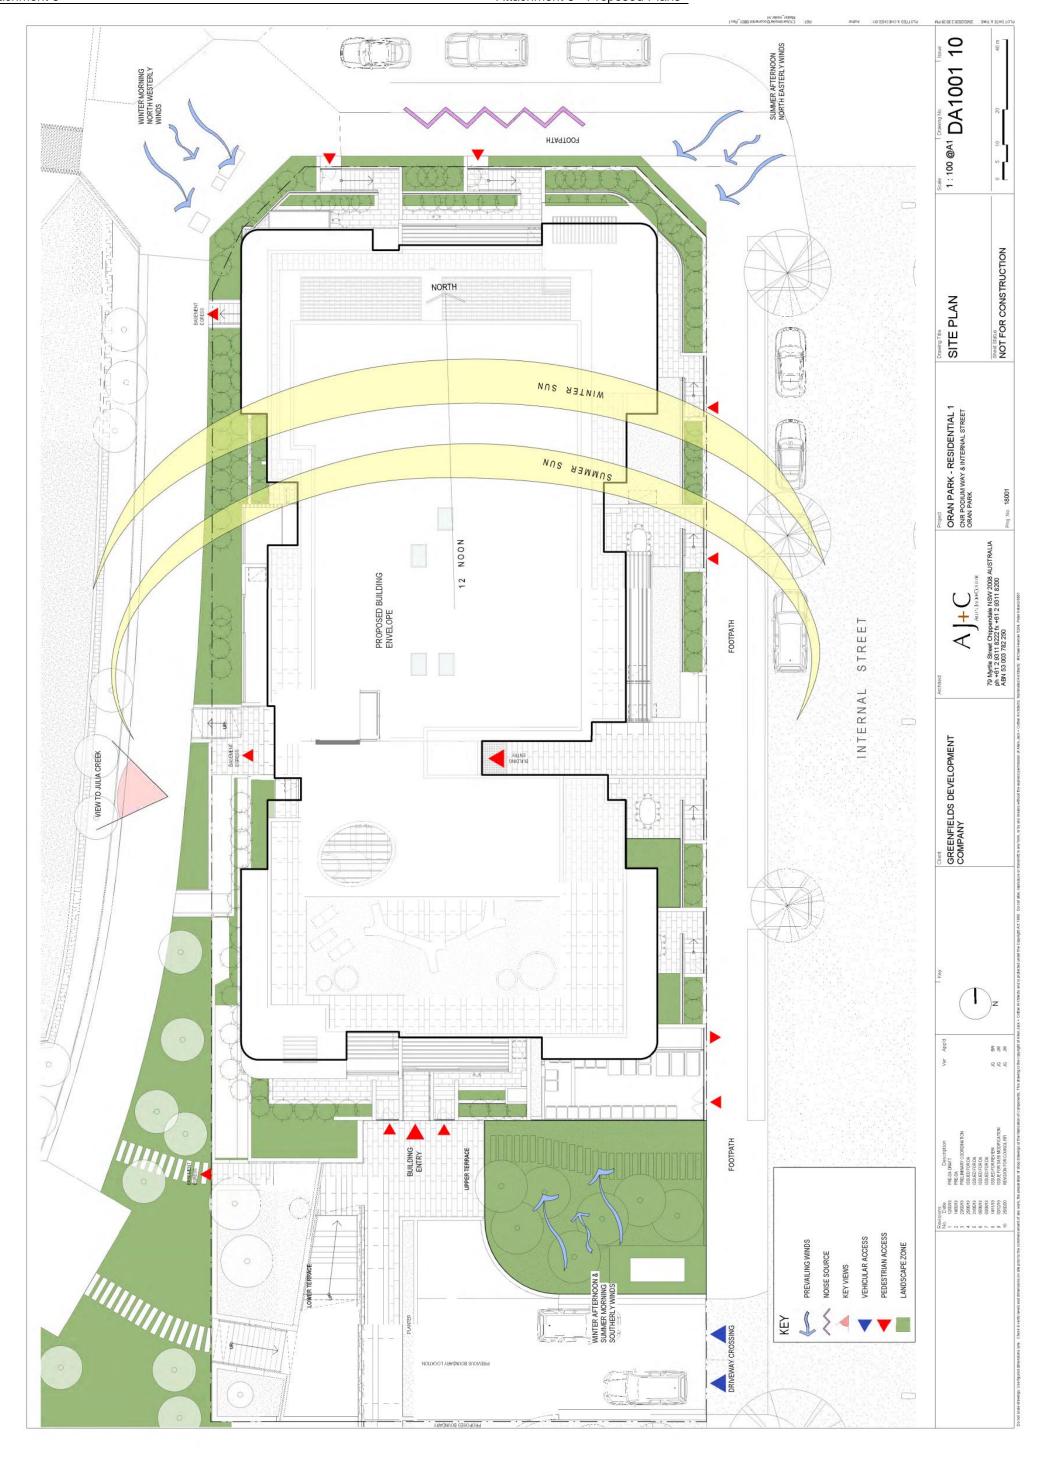
Document Title	Prepared by	Date
BASIX Certificate No. 931257M_02	Thermal Environmental Engineering	17 December 2019
NatHERS Certificate No. 0002831120	ESD Synergy Pty Ltd	7 June 2018

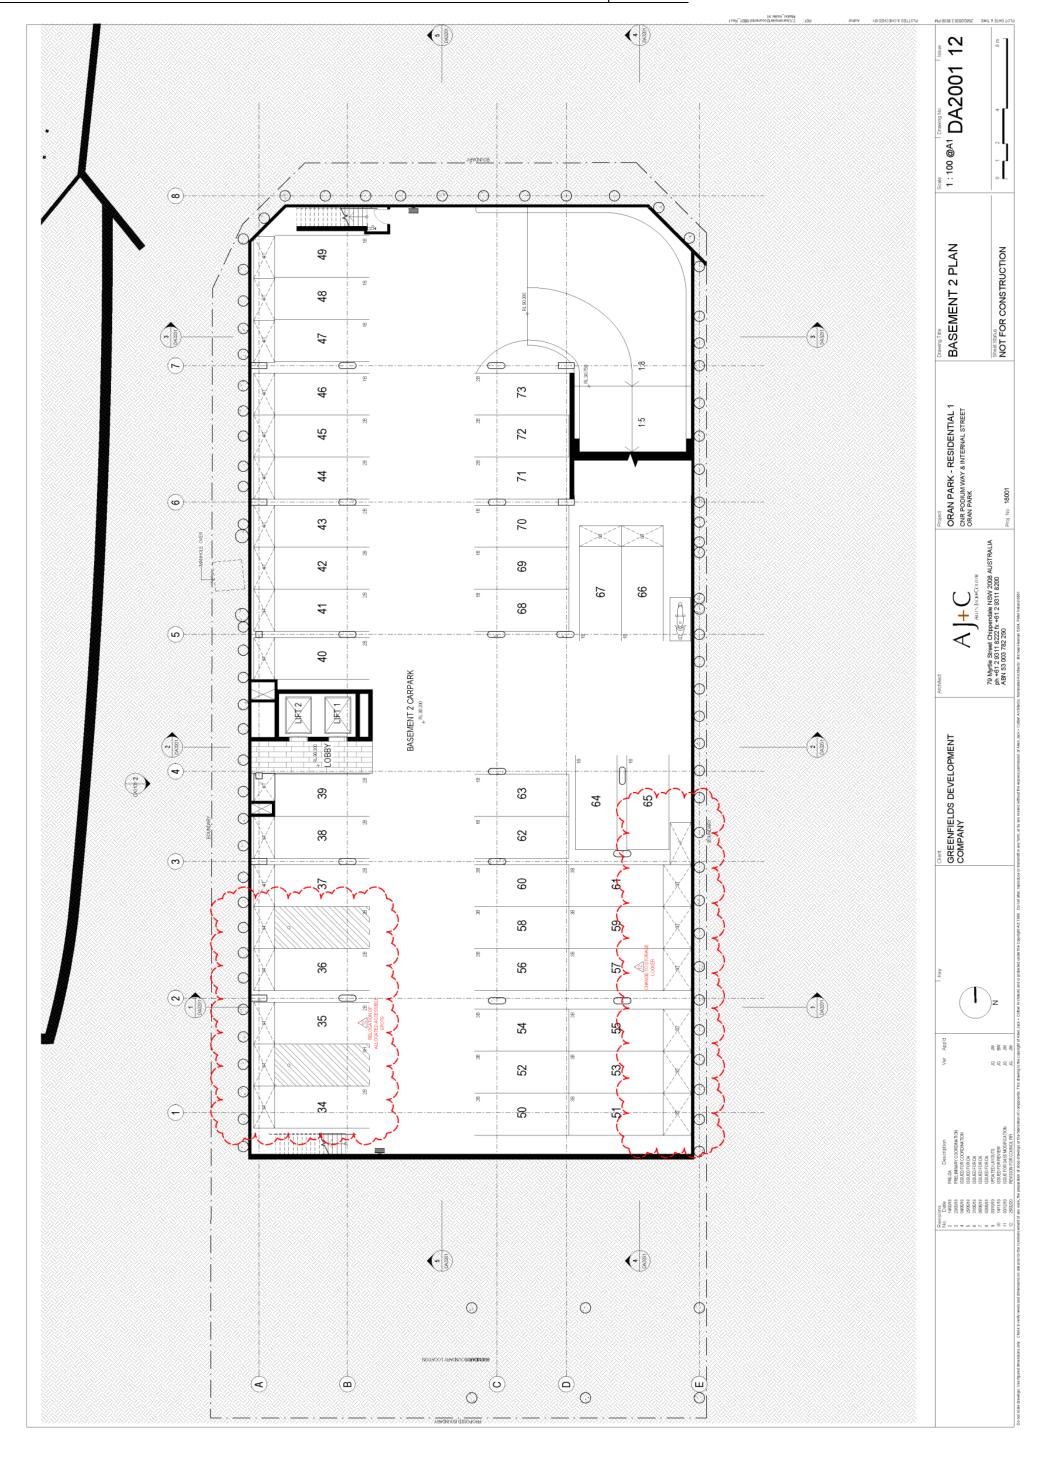
- 1.0(2) **Amended Plans** Prior to the issue of any Construction Certificate amended plans must be submitted to and approved Council indicating the following:
  - a) All units are to be allocated at least one car parking space.
  - b) Car parking spaces should not be obstructed by any other parking space not associated with that unit. All tandem (stacked) spaces must be allocated to a 3 bedroom unit. Both spaces in a tandem (stacked) pair must be associated with the same unit.
  - c) A total of 62 parking spaces allocated to the units (including the accessible spaces for the adaptable units) and 11 visitor spaces (including an electric vehicle only charging station space and an accessible space) must be provided.
  - d) Each of the accessible spaces at level B2 must be allocated to an adaptable unit.

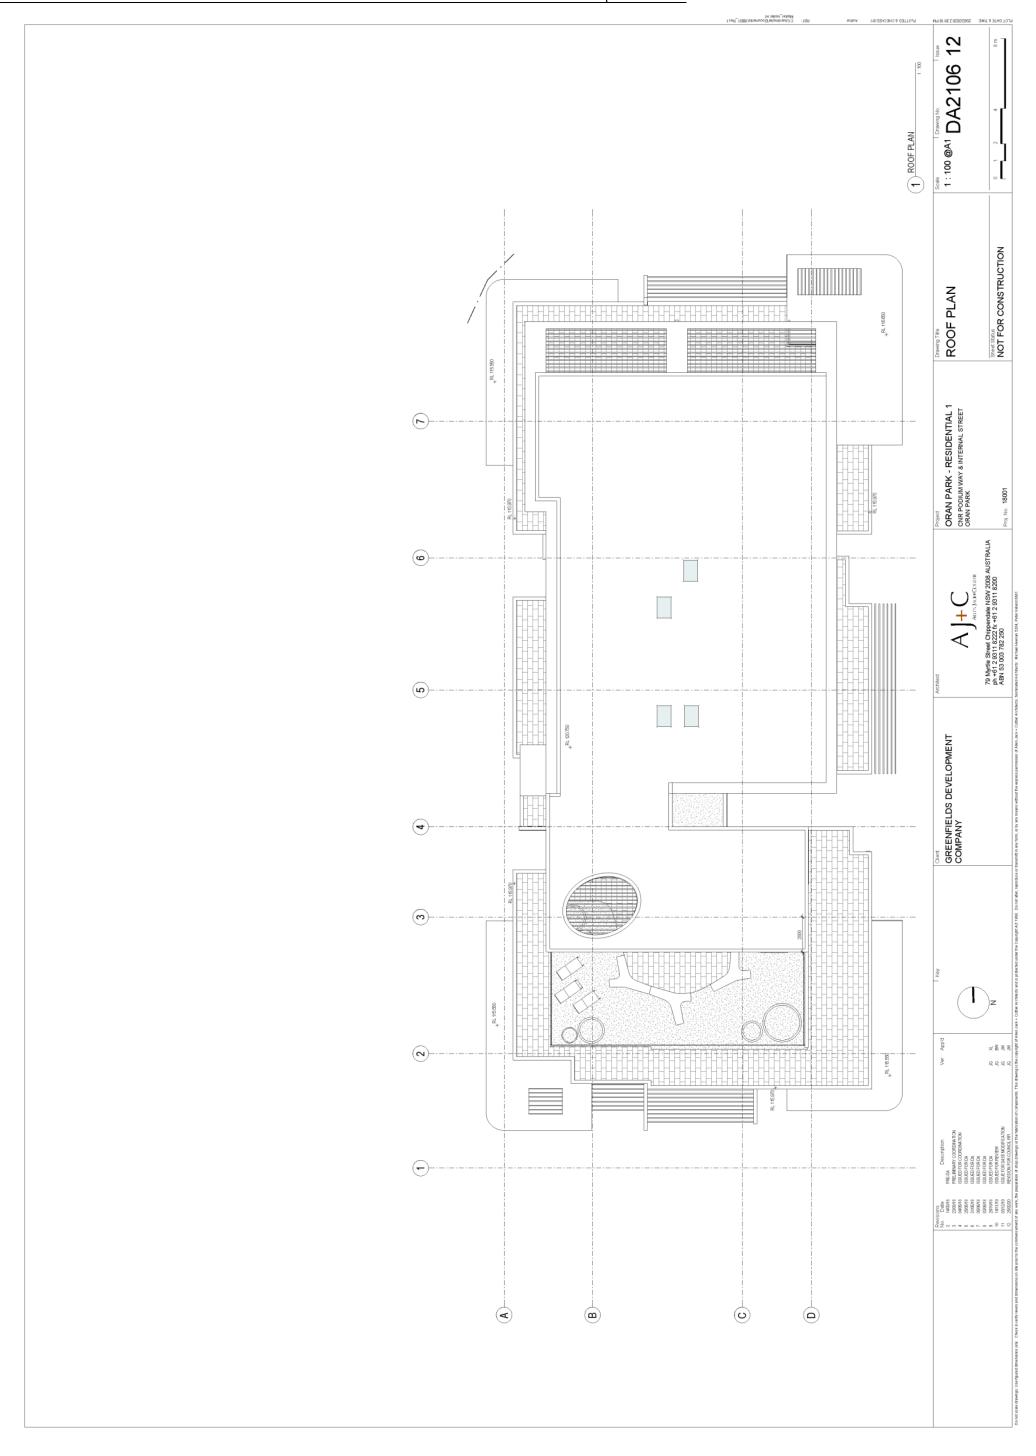
CLPP01

Attachment 5









As indicated DA3101 13

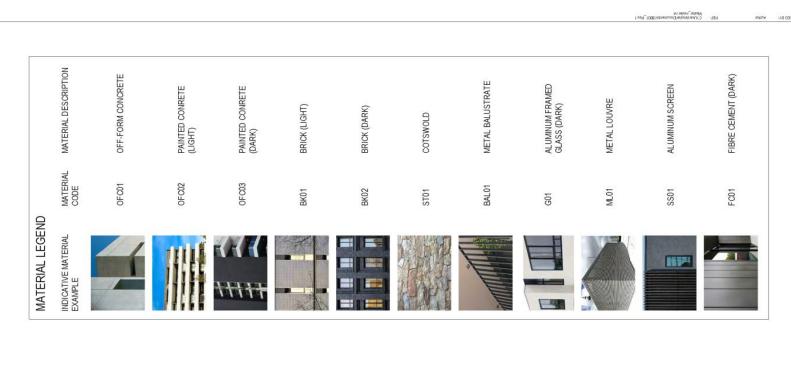
ELEVATIONS - SHEET 1

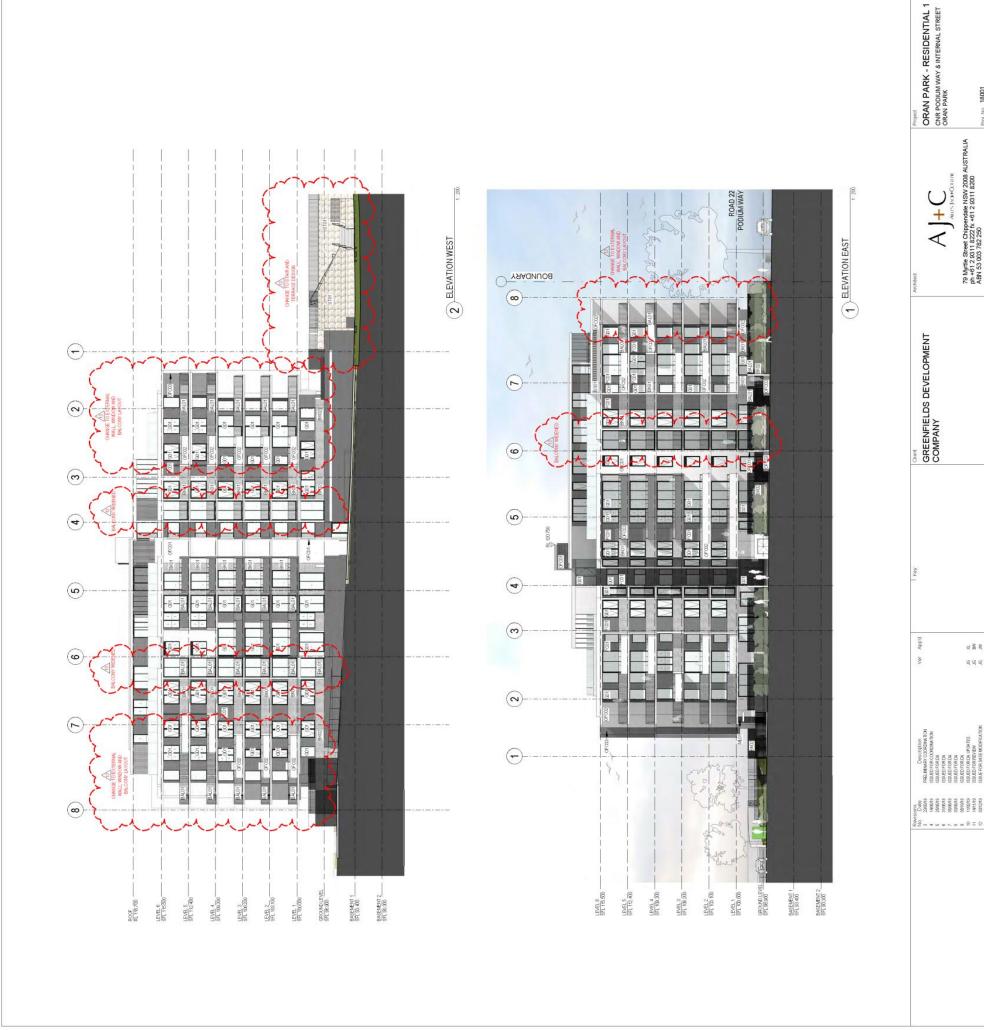
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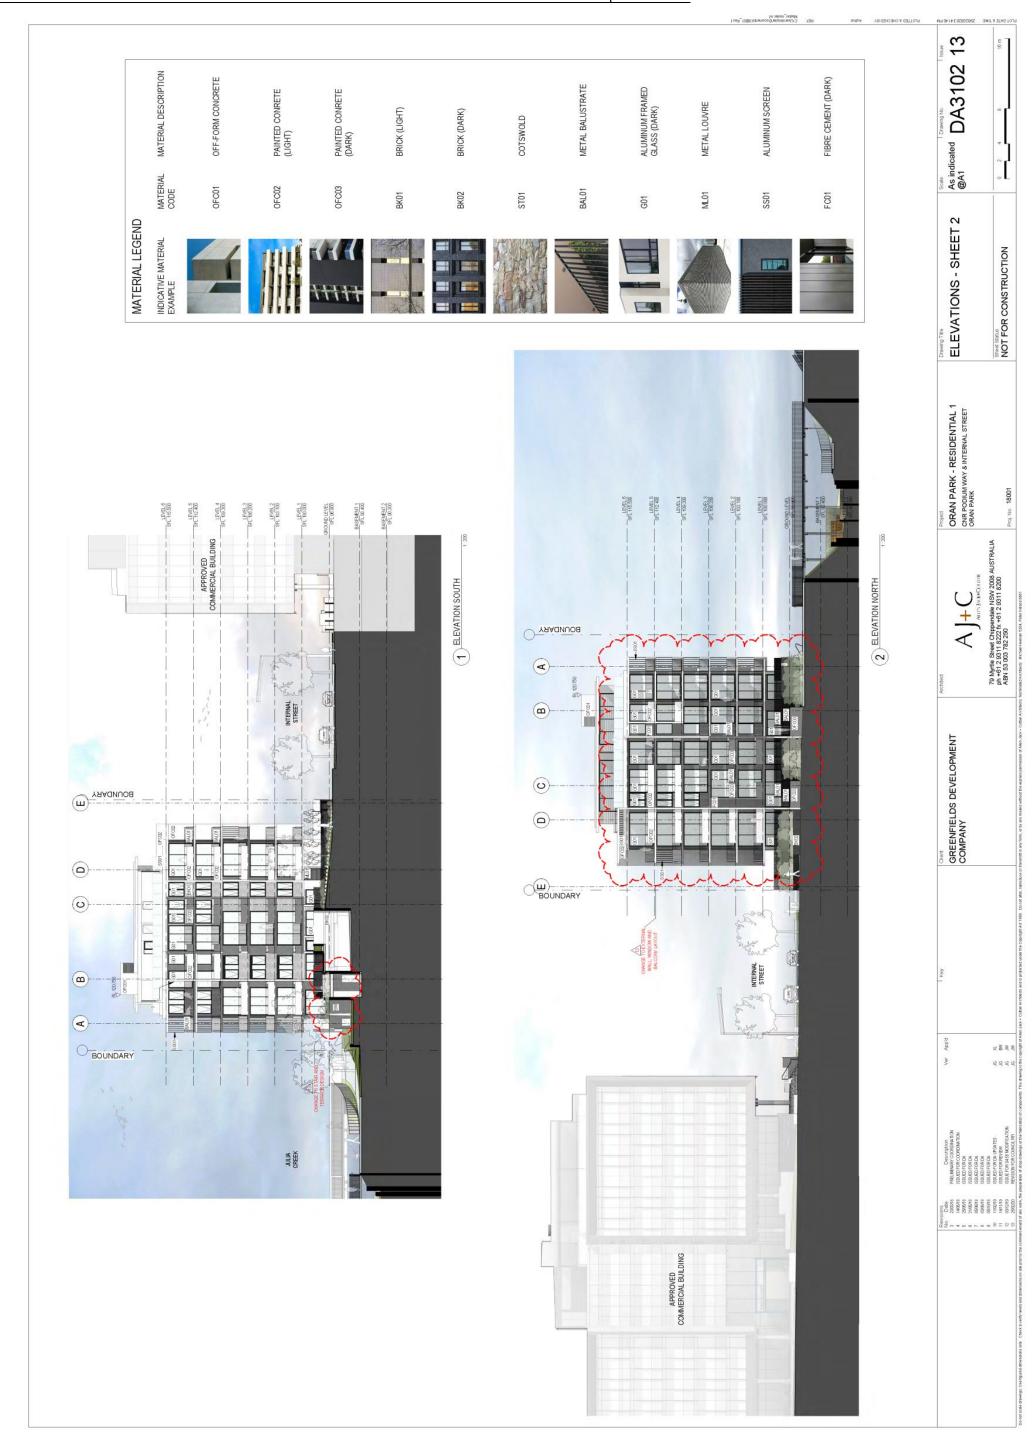
Proj. No. 18001

79 Myrtle Street Chippendale NSW 2008 AUSTRALIA ph +61 2 9311 8222 fx +61 2 9311 8200 ABN 53 003 782 250

8888







A mix of native trees will punctuate the lower terrace and attenuate the retaining wall on the back, whilst a number of silver

more refined planting design on the building surrounds and through the green link that connects Julia Reserve to the Town

Centre providing a smooth transition between the naturalized and civic areas.

The planting strategy uses a mix of robust native and exotic species along the frontage to Julia Creek and progresses to a

birches (Betula nigra) will provide a distinctive character to the Communal Open Space. Ground covers will progress from a mix of native grasses at Julia Reserve into low growing colourful ground covers such as Trachelospermum tricolor and Clivia

Perimeter planting to the building west terraces will be accentuated by tree planting along Julia Reserve, thus providing a

screening effect to the building's West façade

miniata along the terraces' planters.

formal seating can be set out on a synthetic grassed area at the most secluded part of the roof top which comprises the best

views into Julia Reserve and Julia Creek.

herbs, that may be used by the residents. The palette explores a diverse range of leaf colours, textures and volumes to cre-

ate a vivid effect.

Finally, the park furniture and paving materials on both areas are consistent with the palette proposed for Tranche 8 Com-

mercial area 1 ground floor and rooftop areas for consistency and ease of maintenance.

to define the different zones and direct internal circulations. The proposal uses a number of fruit trees and robust kitchen

The use of planters ensures a consistency in the landscape treatment of the roof top and creates screening opportunities

At the roof top communal space, the design approach aims at providing a multi-use space which includes an area for meals,

informal seating, a rest area and play area. Communal tables and seats are located on the shaded areas for comfort and in-

#### For Section 4.55 Approval Julia Reserve Community Centre Tranche 8 Park Town Tranche 8 Resi 1 DA 2017/1627/1 Tranche 25 ranche 3 - Brock Drive Julia Creek Oran DA 746/2015 Tranche 7 Lot 9004 DA 825/1015 South Circuit

Quality residential opportunities are available for people to enjoy all of the benefits of town centre living. The Town Cen-

The vision for the Oran Park Town Centre is to create a people orientated and pedestrian friendly environment, where

Key aspects of the Vision for Oran Park Town Centre identified in the Part B DCP are:

the built form has a human scale at street level, with cultural and civic expression.

tre is prosperous and vibrant during the day and at night and all people feel safe and comfortable moving through the Town

Centre at any time.

block which allows for deep soil planting, outdoor seating and a pedestrian access to the basement and between the Town

The landscape proposal for the residential apartment block and surrounds aims to provide a permeable landscape with a fine balance between public and private space. The apartment block forms a portion of the western edge of the Oran Park Town Centre and faces on to Julia Creek and Julia Reserve. A sizable portion of landscape exists at the southern end of the Centre and Julia Reserve. This area also takes up the level transition through a series of paved terraces and stairs between

the apartment entry at RL 97.60 and Julia Creek at RL 93.40.

The Proposed Development is located within the Oran Park Town Centre and is subject to development controls identified in

the Oran Park Part B Site Specific DCPs specifically Part B1 Oran Park Town Centre adopted 15 October 2015.

JMDdesign have prepared a Landscape Design for a Residential Apartment Block located at the south east corner of Podium

Design Statement

Nov 2019

Way and Julia Creek, Oran Park for GDC2 in Tranche 8. The proposed development is for a six storey residential apartment block with two basement levels of carparking. The apartment block faces west on to the yet to be embellished Julia Creek.

This design statement deals with the landscape treatment of the surrounds to the apartment block, the detail entry treat-

## **Drawing Register**

Drawing No.	Drawing Title	Scale	Issue No.
	Title Sheet	1:2500	А
Loz	Design Analysis & Key Principles 01	1:500	⋖
Lo3	Design Analysis & Key Principles 02	1:500	4
Lo4	Landscape Masterplan	1:250	⋖
Lo5	Detail Plan 01 - Communal Open Space	1:100	<
Po6	Detail Plan o2 - Roof Top	1:100	<
Lo7	Site Sections	As shown	<
Lo8	Indicative Planting Palette - Ground Floor	N/A	4
Log	Indicative Planting Palette - Roof Top	N/A	4
L10	Indivative Materials Palette - Ground Floor	N/A	<
	Indicative Materials Palette - Roof Top	N/A	A

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Check

Drawn

For Section 4.55 Approval Description

29.11.19 Date

GREENFIELDS Development Company

Revisions

info@jmddesign.com.au 

Redfern NSW 2016 T (02) 9310 5644

Oran Park Town Tranche 8 Drawing title Title sheet

1:2500@A1 /1:5000@A3 November 2019 Scale

Drawing No. | Issue No. 

Ø



Development Residential Future

(refer Julia Reserve package)

Commercial building Residential building

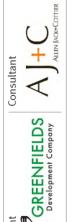
Design Analysis & Key Principles oz Future Commercial Development Planting along retention walls and terraces defines building edge and blends it into the surrounding landscape, softening its implantation on the landscape A number of platforms provide an indirect access to the building uilding 1 Internal Street Holden Drive Lookout point to Julia Creek Residential 1 Development Commercial building Residential building Residential Future Spatial Definition Julia Creek Future Commercial Development uilding 1 Clusters of trees punctuate different platforms & attenuate the retaining wall Internal Street Native trees provide screening to Residential 1 building Holden Drive

Residential 1

Julia Creek

Tree Strategy





For Section 4.55 Approval Description 29.11.19 Date Revisions Issue D

Drawn

BHC

Check BC/JD

JMD design

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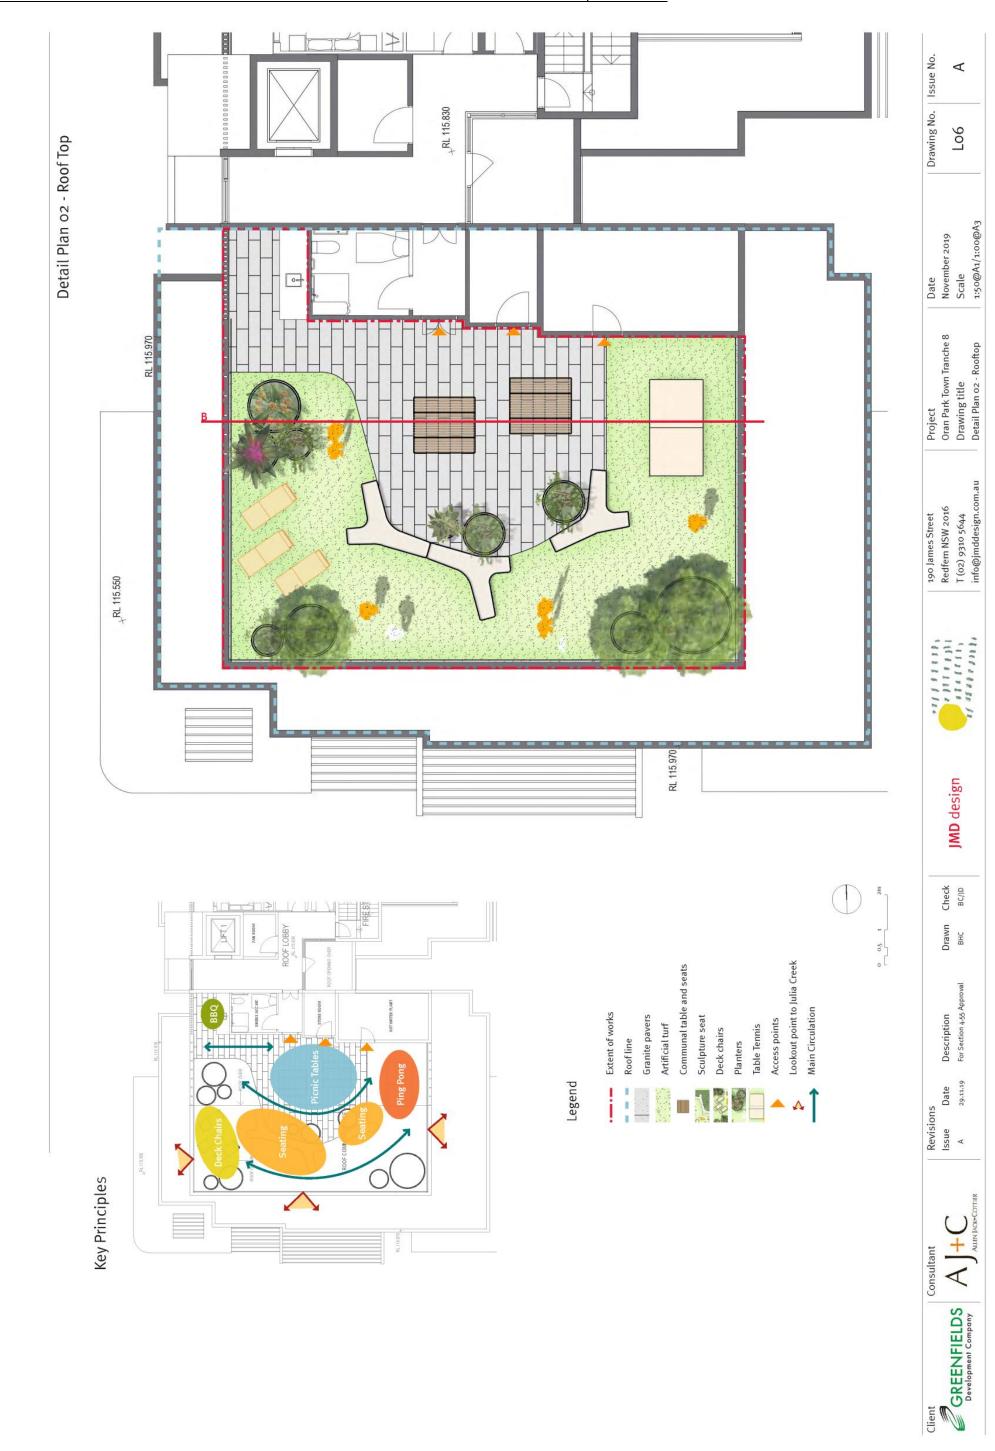
Project Oran Park Town Tranche 8 Drawing title Design Principles

Date November 2019 Scale

1:500@A1 / 1:1000@A3

Lo3





Landscape Masterplan

Drawing No. | Issue No.

JMD design

Check

Drawn

2.5 5

Street trees to Holden Drive to

Sandstone cladded wall

Pit to OSD tank

Ballustrade

Waste Collection Area Electrical Substation

separate submission

Street trees to separate

submission by others

Description

Date

Revisions Issue D

Client

GREENFIELDS

Development Company

--- Extent of works

Access points

Spot levels Mulch area

1:35

Cupaniopsis anacardioides

Tree planting

Betula nigra - Black Birch

Mix of Native Trees

Angophora floribunda Eucalyptus maculata Eucalyptus tereticomis

Granite paving to communal open space

Concrete stepping stones

Precast concrete seat

Feature concrete paving to future detail

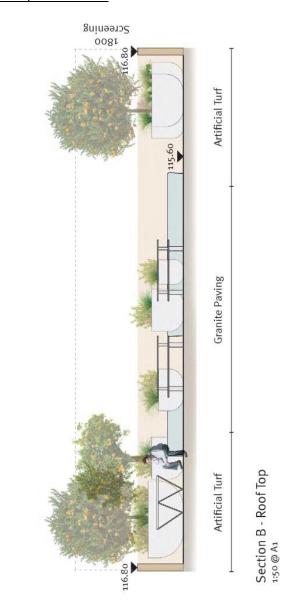
Concrete paving to streetscape

Climbers over waste collection area

Mass planting

Granite pavers to streetscape







Drawing No. | Issue No.

A

Lo7

Date
November 2019
Scale
Scale

Project
Oran Park Town Tranche 8
Drawing title
Site Sections

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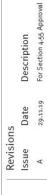














Indicative Planting Palette - Ground Floor

Drawing No. | Issue No.

Lo8

Date
November 2019
Scale
N/A

Project
Oran Park Town Tranche 8
Drawing title
Indicative Planting Palette

JMD design

Check BC/JD

Drawn

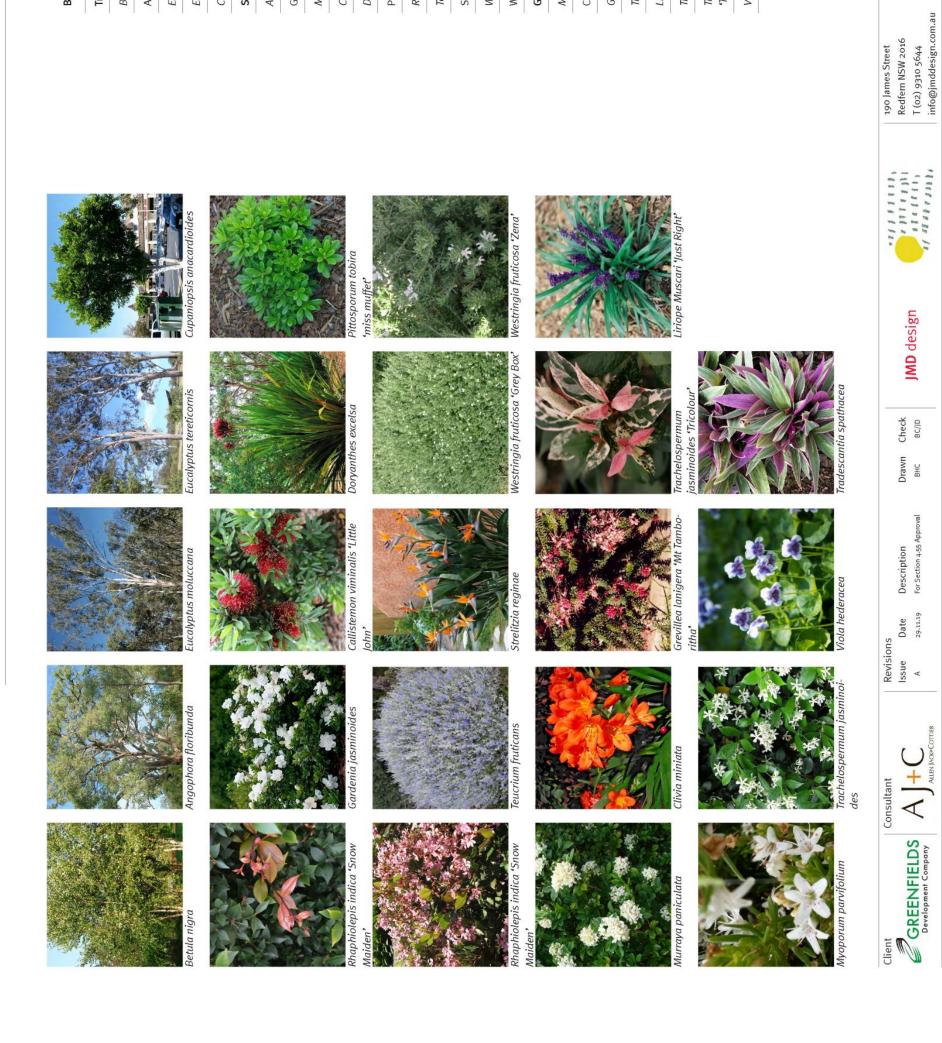
Description For Section 4-55 Approval

Date 29.11.19

GREENFIELDS
Development Company

#### CLPP01

Dotailleat maille	Collinon name	ובוצווו	101 3176
Trees			
Betula nigra	Black Birch	15m	100L
Angophora floribunda	Rough-barked Apple	15-20m	75L
Eucalyptus moluccana	Grey Box	15-20m	75L
Eucalyptus teneticornis	Blue Gum	15-20m	75L
Cupaniopsis anacardioides	Tuckeroo	12m	100L
Shrubs & Feature Plants			
Acmena smithii 'Hot Flush'	Small Leafed Lily Pilly	4m	5L
Gardenia jasminoides	Cape Jasmine	1m	5L
Murraya paniculata	Orange Jessamine	1.2m	5L
Callistemon viminalis 'Little John'	Dwarf Bottlebrush	800mm	5L
Doryanthes excelsa	Gymea Lily	1-2m	45L
Pittosporum tobira 'miss muffet'	Miss Muffet	еоошш	5L
Raphiolepsis indica "Snow Maiden"	Indian Hawthorn	еоошш е	5L
Teucrium fruticans	Bush Germander	еоошш е	5L
Strelitzia reginae	Bird of Paradise	еоошш	45L
Westringia fruticosa 'Grey Box'	Dwarf Native Rosemary	еоошш	5L
Westringia fruticosa 'Zena'	Costal Rosemary	ооошш	5L
Grasses, Groundcovers & Climbers			
Myoporum parvifolium	Creeping Boobialla	200mm	140mm
Clivia miniata	Natal Lily	350mm	140mm
Grevillea lanigera 'Mt Tamboritha'	Spinder Flower	Зоошш	140mm
Trachelospermum jasminoides	Star Jasmine	Зоошш	140mm
Liriope Muscari 'Just Right'	Turf Lily	500mm	140mm
Tradescantia spathacea	Boatlily	Зоошш	140mm
Trachelospermum jasminoides Tricolour²	Star Jasmine	200mm	140mm
Viola hederacea	Native Violets	100mm	90x50x50



Botanical name         Common name         Height         Pot size           Citrus hystrix         Kaffir Lime         1.5m         45L           Citrus limon 'Meyer'         Meyer Lemon         1.5m         45L           Citrus sinensis         Navel Orange         1.5m         45L           Shrubs & Herbs in pots         Tarragon         400mm         140mm           Artemisia dracunculus         Tarragon         140mm           Artemisia dracunculus         Chives         300mm         140mm           Gallum schoenoprasum         Chives         500mm         140mm           Cymbopogon citratus         French Lavender         500mm         140mm           Cymbopogon citratus         French Lavender         500mm         140mm           Mentha spicata         Spearmint         200mm         140mm           Oregano vulgare         Oregano         100mm         140mm           Salvia officinalis         Sage         300mm         140mm           Thymus citriodorus         Citrus Thyme         200mm         140mm           Thymus vulgaris         Garden Thyme         200mm         140mm		Indicative Planting Palette - Roof Top	g Palette - R	oof Top
Kaffir Lime     1.5m       Meyer Lemon     1.5m       Navel Orange     1.5m       Iarragon     400mm       Chives     300mm       Woodruff     300mm       French Lavender     500mm       Spearmint     200mm       Oregano     100mm       Rosemary     700mm       Sage     300mm       Citrus Thyme     100mm       Garden Thyme     200mm	Botanical name	Common name	Height	Pot size
Meyer Lemon 1.5m  Navel Orange 1.5m  Tarragon 400mm  Chives 300mm  Woodruff 300mm  French Lavender 500mm  Spearmint 200mm  Oregano 100mm  Rosemary 700mm  Sage 300mm  Citrus Thyme 100mm  Garden Thyme 200mm	Citrus hystrix	Kaffir Lime	1.5m	45L
Navel Orange 1.5m  Tarragon 400mm Chives 300mm Lemon Grass 500mm Woodruff 300mm French Lavender 500mm Oregano 100mm Rosemary 700mm Sage 300mm Citrus Thyme 100mm	Citrus limon 'Meyer'	Meyer Lemon	1.5m	45L
Chives 300mm Lemon Grass 500mm Woodruff 300mm French Lavender 500mm Oregano 100mm Rosemary 700mm Sage 300mm Citrus Thyme 100mm	Citrus sinensis	Navel Orange	1.5m	45L
Tarragon 400mm Chives 300mm Lemon Grass 500mm Woodruff 300mm French Lavender 500mm Oregano 100mm Rosemary 700mm Sage 300mm Citrus Thyme 100mm	Shrubs & Herbs in pots			
Chives 300mm Lemon Grass 500mm Woodruff 300mm French Lavender 500mm Spearmint 200mm Oregano 100mm Rosemary 700mm Sage 300mm Gitrus Thyme 100mm	Artemisia dracunculus	Tarragon	400mm	140mm
Spearmint Soomm  Oregano  Iis Rosemary  Sage  Citrus Thyme  Carden Thyme  Soomm  Soomm  Soomm  Sage  Sage  Sage  Soomm  Comm  Sage  Soomm  Sage  Soomm  Sage  Soomm  Sage  Soomm  Sage  Soomm  Sage  Soomm	Allium schoenoprasum	Chives	Зоотт	140mm
Woodruff     300mm       French Lavender     500mm       Spearmint     200mm       Oregano     100mm       lis     Rosemary     700mm       Sage     300mm       Citrus Thyme     100mm       Garden Thyme     200mm	Cymbopogon citratus	Lemon Grass	500mm	140mm
French Lavender 500mm Spearmint 200mm Oregano 100mm lis Rosemary 700mm Sage 300mm Citrus Thyme 100mm Garden Thyme 200mm	Galium odoratuma	Woodruff	Зоошш	140mm
e     Oregano     100mm       cinalis     Rosemary     700mm       s     Sage     300mm       rus     Citrus Thyme     100mm       s     Garden Thyme     200mm	Lavandula stoechas	French Lavender	200тт	140mm
Oregano 100mm Rosemary 700mm Sage 300mm Citrus Thyme 100mm Garden Thyme 200mm	Mentha spicata	Spearmint	200mm	140mm
Sage 300mm  Citrus Thyme 100mm  Garden Thyme 200mm	Oregano vulgare	Oregano	100mm	140mm
Sage 300mm us Citrus Thyme 100mm Garden Thyme 200mm	Rosmarinus officinalis	Rosemary	700mm	140mm
us Citrus Thyme 100mm Garden Thyme 200mm	Salvia officinalis	Sage	Зоошш	140mm
Garden Thyme 200mm	Thymus citriodorus	Citrus Thyme	100mm	140mm
	Thymus vulgaris	Garden Thyme	200mm	140mm



A

L10

Drawing No. | Issue No.

Date
November 2019
Scale
N/A

Project
Oran Park Town Tranche 8
Drawing title
Indicative Materials Palette

190 James Street Redfem NSW 2016 T (02) 9310 5644 info@jmddesign.com.au

Indicative Materials Palette - Ground Floor







400×400×40mm 'Raven Black' exofoliated granite















1000 x 300 x 40mm 'Sesame Grey' exofoliated granite

JMD design



Check	BC/JD

This is the report submitted to the Camden Local Planning Panel held on 19 May 2020 - Page 53

Indicative Materials Palette - Roof Top



Sculpture seating















Ping pong table



'Sesame Grey' exofoliated granite 1000 x 300 x 40mm



Deck chairs





2 2 4 5 5 3 9 5 2 3 4 7 5 5 3 5 3 3 4 6 6 5 5 5 3 4 4 6 6 5 5 5 5 5

Drawing No. | Issue No.

A

L11

Date
November 2019
Scale
N/A

Project
Oran Park Town Tranche 8
Drawing title
Indicative Materials Palette

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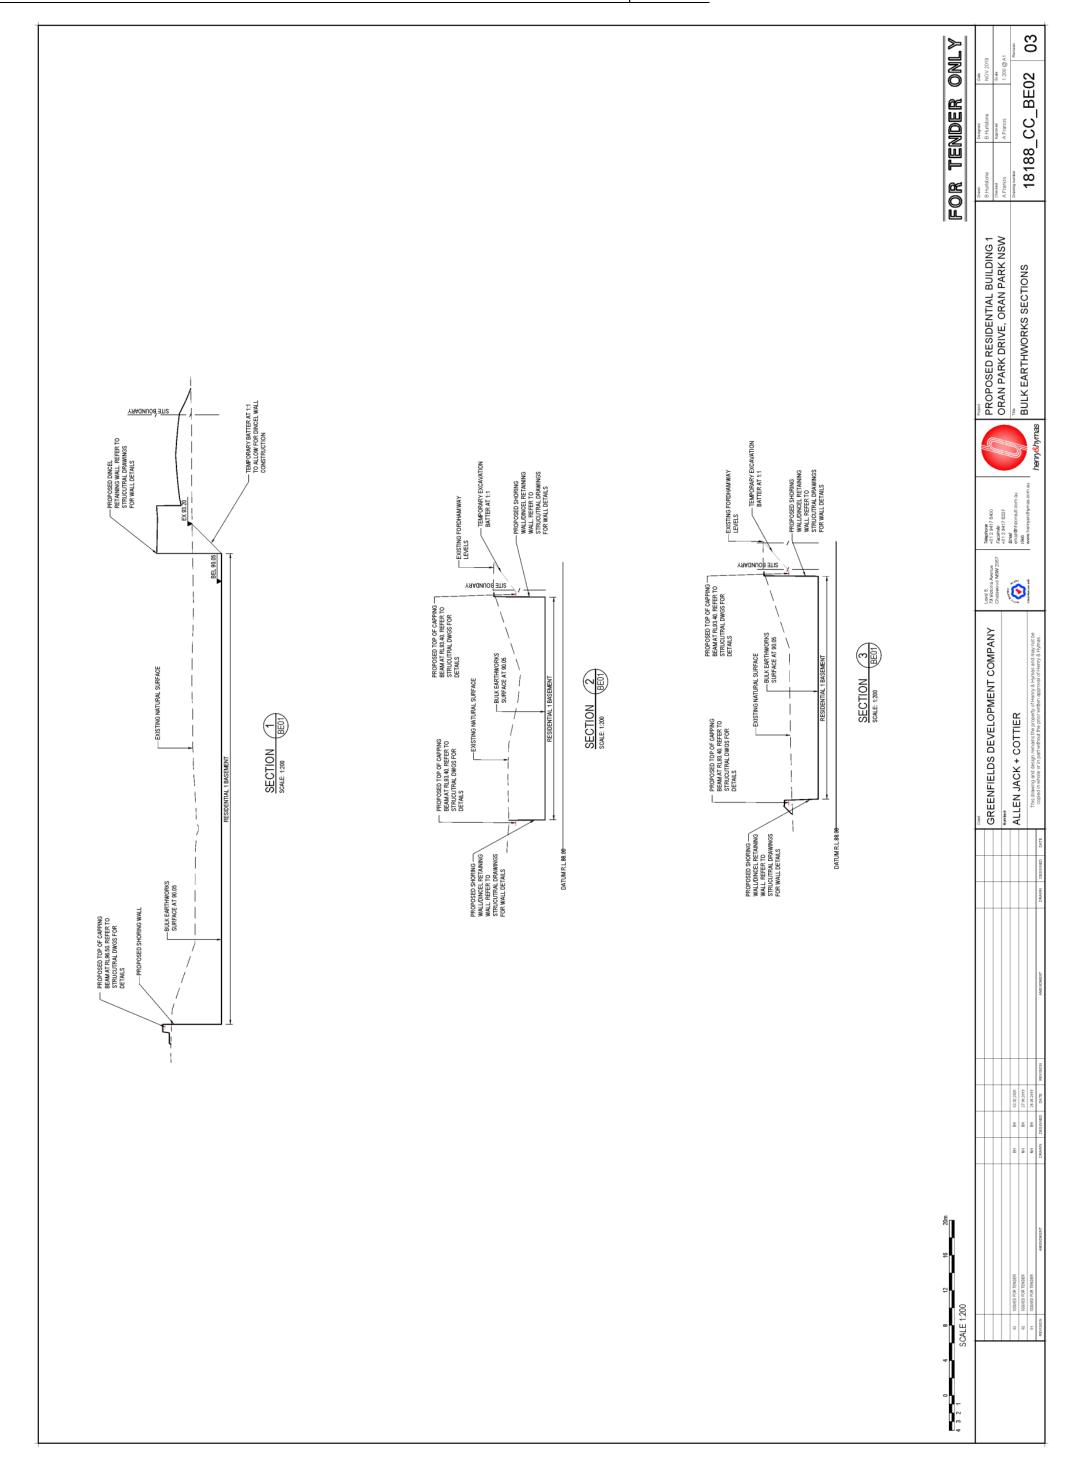


Description For Section 4.55 Approval





Attachment 5 - Proposed Plans Attachment 5 CLPP01 PROPOSED LINTEL ONGRADE & SAG PITS FOR CONSTRUCTION CERTIFICATE 18188\_CC\_BE01 PROPOSED LIMIT OF WORK PROPOSED JUNCTION PITS **BULK EARTHWORKS QUANTITIES** EXCAVATION FOR RETAINING WALLS NOT INCLUDED IN CALCULATION EXCAVATION FOR SERVICE TRENCHES NOT INCLUDED IN CALCULATION DEPTH OF CUT & FILL RANGE LOWER VALUE 98.70 LEGEND PROPOSED COMMERCIAL BUILDING ORAN PARK DRIVE, ORAN PARK, NSW Attachment 5 LOWER BASE COURSE SHALL BE CONSTRUCTED FROM CRUSHED SANDSYCHE COMPLET DY 00%-STANDARD DRY DENSITY RATIO AT DETMINAMOSTIBLE CONTENT ± 2% IN ACCORDANCE WITH AS 1288 5.1.1. OF THICKNESS NOTED ON DRAWINGS. SUB-GRADE SHALL BE COMPACTED TO 89%STANDARD DRY DENSITY RATIO AT OPTIMUM MOISTURE CONTENT ± 2%IN ACCORDANCE WITH AS 1299 5.1.1 TOP 300MM TO 100%SDD. BULK EARTHWORKS hem/&hymas | CUT/FILL PLAN HENRY AND HYMAS PTY LID CANNOT GUARANTEE THAT THE SERVICES INFORMENT ON SHOWMENT ON SHOOMENT WIS ANCIDENTED. PRESENCE OF SERVICES OF THEIR LOCATION AND WILL A CCEPT NO LUBBILITY FOR INACCURACIES IN THE SERVICES INFORMATION SHOWN MARRIAN FORMAT VALUES WINTSTOWER. CONTRACTIONS ARE TO CONTRACTION THE RELEVANT SERVICE ALTHORITY PRINT TO COMMENCEMENT OF EXCANATION. PRINT FOR COMMENCEMENT OF EXCANATION. TESTING OF THE SUBGRADE AND PAVEMENT LAYERS SHALL BE CARRIED OUT BY APPROVED N.A.T.A. REGISTERED LABORATORY. BULK EARTHWORKS GENERAL NOTES THE COMPACTOR WILL IMPORT SUITABLE FILL FROM AN EXTERNAL SOURCE, EXCANTION MATERIALS MEETING THE PROUNED SPECIFICATION MAY BE USED AS FILL THIS MAY INCLUDE RECYCLED MATERIALS IF THEY AS EST TABLY BE ENDED/CONDITIONED TO MEET MATERIALS. THE LOCATIONS OF UNDERGROUND SERVICES SHOWN ON THESE MANINGSTANCE BENDELING TO STREAM STANDER AND AUTHORITY INFORMATION THE SERVICE INFORMATION HAS BEEN PREPARED ONLY TO THE OFFICE THE SERVICE OF ANY TO SHAWNOWN SERVICES AND MAY NOT BE AS OFFICE THE OFFI SHOWN THE POSTIONS FANY INFORMIN SERVICES AND MAY NOT BE AS OFFI SHOWN THE POSTION OF ANY INFORMIN SERVICES AND MAY NOT BE AS OFFI SHOWN THE POSTION OF ANY INFORMATION OF THE PROPERTY. PREPARATION FOR PAVEMENT: CLEAR SITE, STRIP TOP-SOIL, CUT AND FILL AND PREPARATIONS OF SUB-GRADE SHALL BE AS DESCRIBED IN\* SUBGRADE PREPARATION\* BASE COURSE SHALL BE CONSTRUCTED FROM FINE CRUSHED ROCK COMPACTED TO MOSESTANDED DRY DENSITY RATIO AT OFTIMJIM MOISTURE CONTENT # 2%AIN ACCORDANCE WITH AS 1289 5.1.1 OF THONNESS NOTED ON DRAWINGS. WEARING SURFACE SHALL BE ASPHALTIC CONCRETE TO STANDARD SPECIFICATION, MINIMUM THICKNESS = 30mm U.N.O. LI, TOP SOIL, ORGANO MATTER AND FIL MATERIAL SHALL BE RELAKON TO THE TROMALL BEELS INDER BUILDING AND CHRONEERS, KLOST TONGS SAIN SPACION OF THE GEOTE CHRONEERS, AREAS TO BE FLALL STREPED OF ENSITING FILL AND DARK BROWN BLACK UPPER ORGANIAL MUNIMARY. REFER TO GEOTECHNICAL INVESTIGATION REPORT FOR INFORMATION RELATING TO EXISTING GROUND CONDITIONS, SITE TREATMENT AND SI IPPERVISION ALL SERVICES ARE TO BE LOCATED AND CUT OFF PRIOR TO THE COMMENCEMENT OF EXCAVATION AND FILLING OPERATIONS. COMPACTION REQUIREMENTS Level 5, 79 Victoria Avenue Chatswood NSW 2067 ( GREENFIELDS DEVELOPMENT COMPANY ALLEN JACK + COTTIER CH 00.000 → YAW MAHUROA YAW MAHOROR BULK EARTHWORKS CUT/FILL PLAN PROPOSED RESIDENTIAL BUILDING 1 BEP 90.05



# ORAN PARK DRIVE, ORAN PARK NSW PROPOSED RESIDENTIAL BUILDING CIVIL ENGINEERING WORKS

#### GENERAL NOTES

- A COUNCIL'S D RETAIN A COPY ON SITE
- STING CONDITIONS AND ALL NEW WORKS ARE TO MAKE A SMOOTH JUNCTION WITH EX MARRY IN A "WORKMANLIKE" MANNER.
- BE MAINTAINED IN SERVICES & ACCESSES TO THE EXISTING WORKING ORDER AT ALL TIMES DURING (
- VELS TO RELEVANT
- REINSTATE AND STABILISE ALL DISTURBED LANDSCAPED
- ECTIONS ACROSS THE CONTRACTOR TO CHECK AND CONFIRM SITE DRAINAGE CO VERGE PRIOR TO COMMENCEMENT OF SITE DRAINAGE WOF
  - ADVANCE WHERE PROPERTIES AFFECTED BY THE WORKS ARE TO BE NOTIFIED DISRUPTION TO EXISTING ACCESS IS LIKELY.



LOCALITY SKETCH scale: NTS.

DRAWING SCHEDULE	COVER SHEET, DRAWING SCHEDULE, NOTES AND LOCALITY SKETCH	GENERAL ARRANGEMENT PLAN	DETAIL PLAN - GROUND FLOOR	STORMWATER MISCELLANEOUS DETAILS AND PIT LID SCHEDULE	OSD PLAN, SECTIONS AND DETAILS	SEDIMENT AND EROSION CONTROL PLAN	SEDIMENT AND EROSION CONTROL DETAILS	BULK EARTHWORKS CUT & FILL PLAN	BULK EARTHWORKS SECTION
	18188_CC_C000	18188_CC_C100	18188_CC_C101	18188_CC_C200	18188_CC_C201	18188_CC_SE01	18188_CC_SE02	18188_CC_BE01	18188 CC BE02

O MAINTAIN SUPPLYTO
STO THE SATISFACTION AND
OMPLETE AND
H TEMPORARY SERVICES AND

IONE SO AS NOT TO CAUSE IN APPROVAL FROM THE

TREES SHOWN ON THESE ON WORKS.

EXISTING SERVICES, BUILDINGS, EXTERNAL STRUCTURES AN DRAWINGS ARE EXISTING FEATURES PRIOR TO ANY DEMOLIT

S SHALL GAIN APPROVAL OF PORARY SERVICES.

ES TO ALL BUILDINGS NOT

THE CONTRACTOR SHALL ENSURE THAT AT ALL TIMES AFFECTED BY THE WORKS ARE NOT DISRUPTED.

THE CONTRACTOR SHALL ALLOW FOR THE CAPPING OFF, EXC RECOURSD) OF ALL EXISTING SERVICES IN AREAS AFFECTED CONTRACT AREA OR AS SHOWN ON THE DRAWINGS UNLESS! THE SUPERINTENDENT.

EXISTING SERVICES & FEATURES

### SITEWORKS NOTES

- ORIGIN OF LEVELS : REFER TO BENCH OR STATE SURVEY MARKS WHER SHOWN ON PLAN.
- CONTRACTOR MUST VERIEY ALL DIMENSIONS AND EXISTING LEVELS ON PRIOR TO THE COMMENCEMENT OF WORK.
- ALL WORKS TO BE UNDERTAKEN IN ACCORDANCE WITH THE DETAILS SHOW THE DRAWINGS & THE DIRECTIONS OF THE SUPERINTENDENT.
- WHERE NEW WORKS ABUT EXISTING THE CONTRACTOR SHALL ENSUI SMOOTH EVEN PROFILE, FREE FROM ABRUPT CHANGES IS ACHIEVED
  - THE CONTRACTOR SHALL ARRANGE ALL SURVEY SETOUT TO BE CAR BY A REGISTERED SURVEYOR.
    - CARE IS TO BE TAKEN WHEN EXCAVATING NEAR EXISTING SERVICES MECHANICAL EXCAVATION IS TO BE UNDERTAKEN OVER TELSTRA OF ELECTRICAL SERVICES. HAND EXCAVATE IN THESE AREAS.
      - CONTRACTOR TO OBTAIN AUTHORITY APPROVALS WHERE APPLICA
      - MAKE SMOOTH TRANSITION TO EXISTING SURFACES AND MAKE
- THESE PLANS SHALL BE READ IN CONJUNCTION WITH APPROPER THE STRUCTURAL, HYDRAULIC AND MECHANICA DR WRITTEN INSTRUCTIONS THAT MAY BE ISSUED RELATING TO DEVELOPMENT AT THE SITE.
  - TRENCHES THROUGH EXISTING ROAD AND CONCRETE PAVEMENT. SAWCUT TO FULL DEPTH OF CONCRETE AND A MINIMUM OF 50mm BITUMNOUS PAVING.
- GRADES TO PAVEMENTS TO BE AS IMPLIED BY RL'S ON PLAN. GRADE EVER BETWEEN NOMINATED RL'S. AREAS EXHIBITING PONDING GREATER THAN 5 DEPTH WILL NOT BE ACCEPTED UNLESS IN A DESIGNATED SAG POINT.
  - ALL COVERS AND GRATES ETC TO EXISTING SERVICE UTILITIES ARE TO BE ADJUSTED TO SUIT NEW FINISHED SURFACE LEVELS WHERE APPLICABLE.

THE INFORMATION IS SHOWN TO PROVIDE A BASIS FOR DESIGN HEINRY MID HANDAY SPILL TO DESIGN UNCENTREET HE ACCOUNT OF THE OWNER PROVIDED HAND SUFFICIENT OF THE SINGLY SAGE ON ITS SUITABILITY AS A BASIS FOR SOONS ITS CHORT SUITABILITY AS A BASIS FOR SOONS ITS CHORT SUITABILITY ON SOME SET ON SUITABILITY ON SOME SET WAS CHORT HE SINGLY DATA AND ACTUAL HELD DATA. CONTACT HENRY MED HANDS TYLL LD. THE POLLOWING NOTES HAVE BEEN TAKEN DIRECTLY REMOVED THE SURVEY DATA AND PARAD. THE EXISTING SITE CONDITIONS SHOWN ON THE FOLLOWING DRAWII HAVE BEEN INVESTIGATED BY THE SURVEYOR SPECIFIED IN THE TITI

# FOR TENDER ONLY

Drawn	Designed	Date	
M.Cerna	N.Heazlewood	NOV 2019	81
Checked	Approved	Scale	
A.Francis	A.Francis	N.T.S.	
Drawing number			Revision
18188	SS	0000	75

PROPOSED RESIDENTIAL BUILDING ORAN PARK DRIVE, ORAN PARK, NSW

Level 5, 79 Vintoria Avenue Chatswood NSW 2067

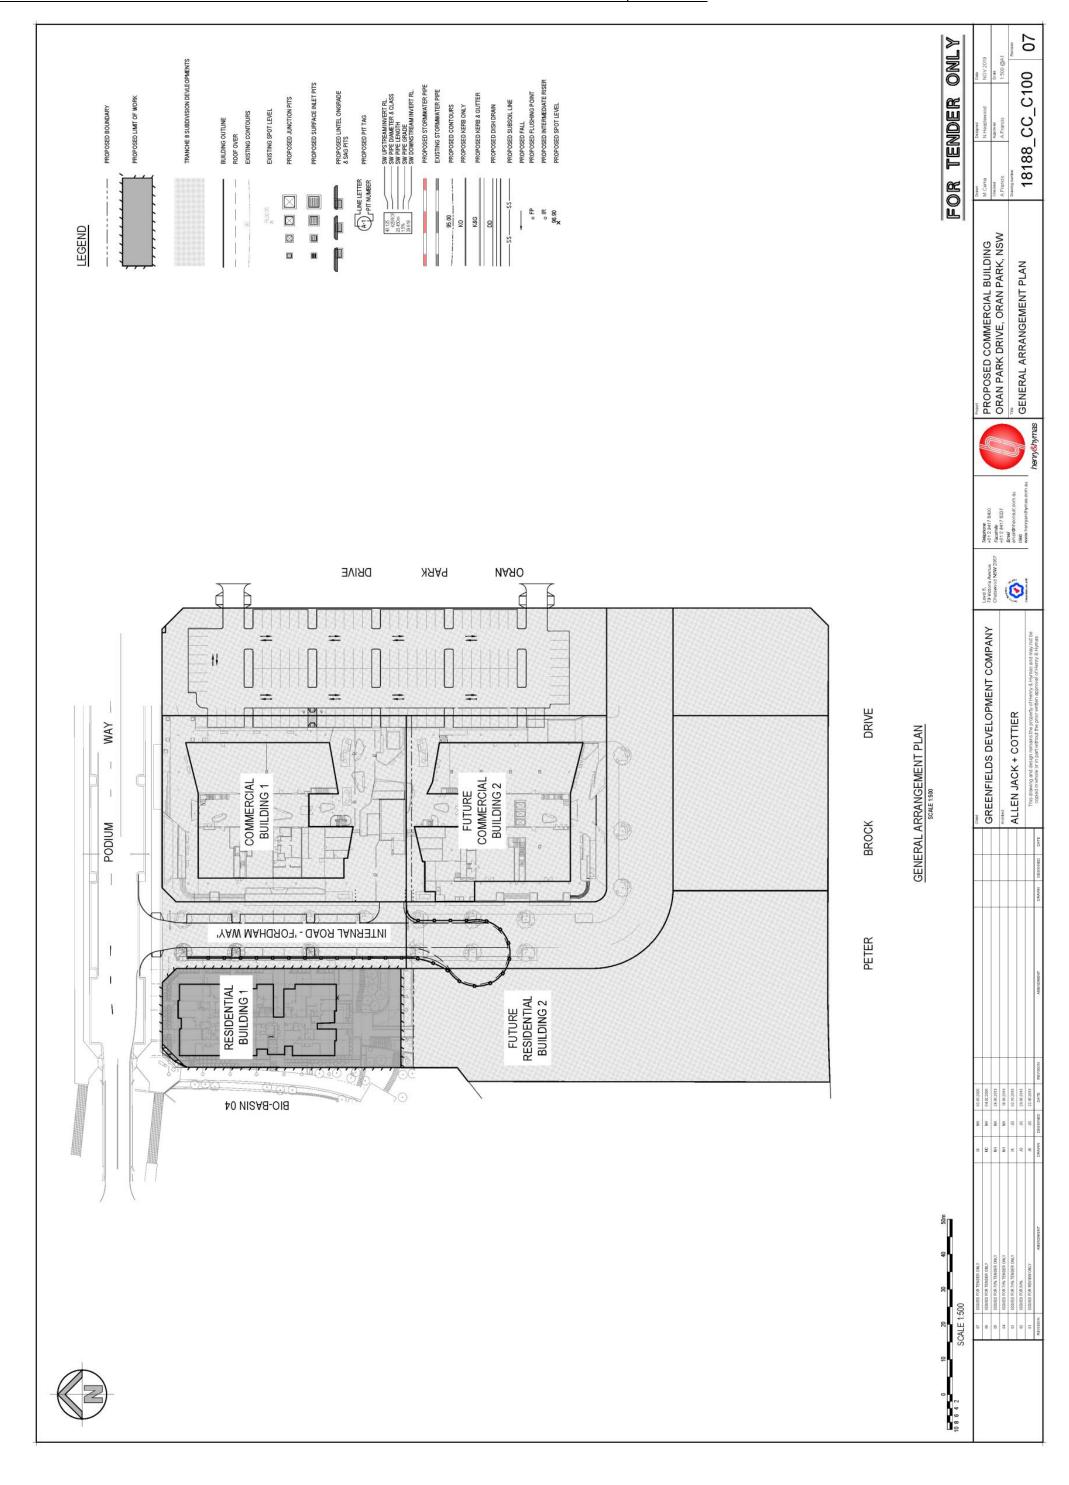
GREENFIELDS DEVELOPMENT COMPANY

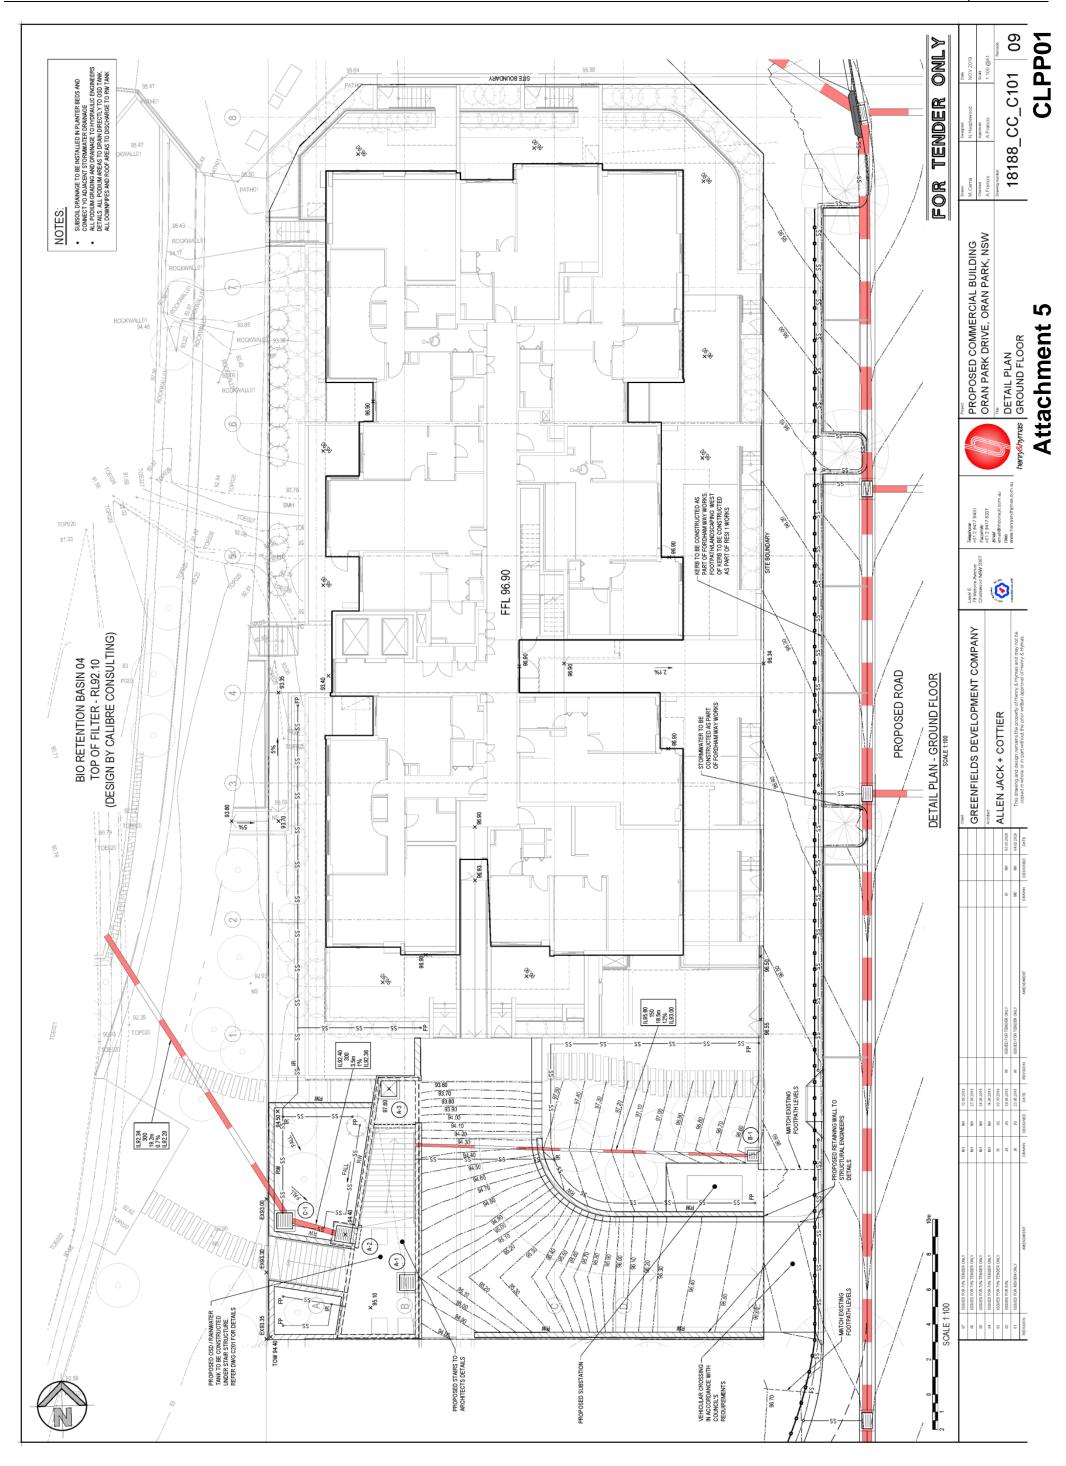
ALLEN JACK + COTTIER

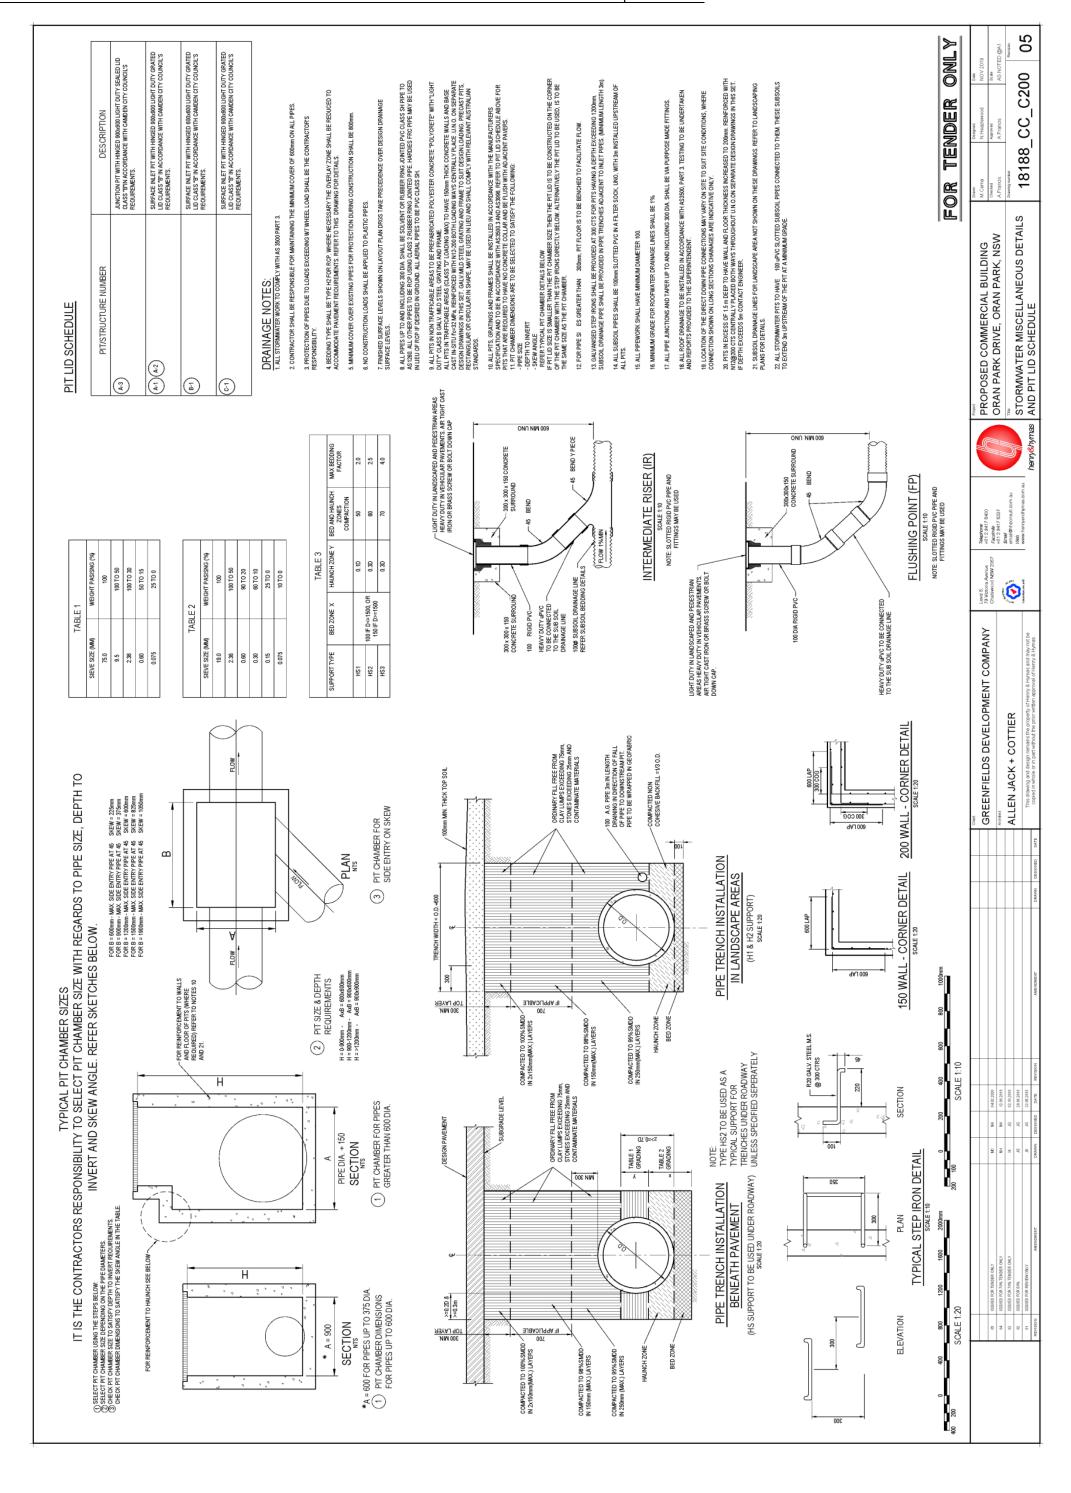
COVER SHEET, DRAWING SCHEDULE, NOTES AND LOCALITY SKETCH

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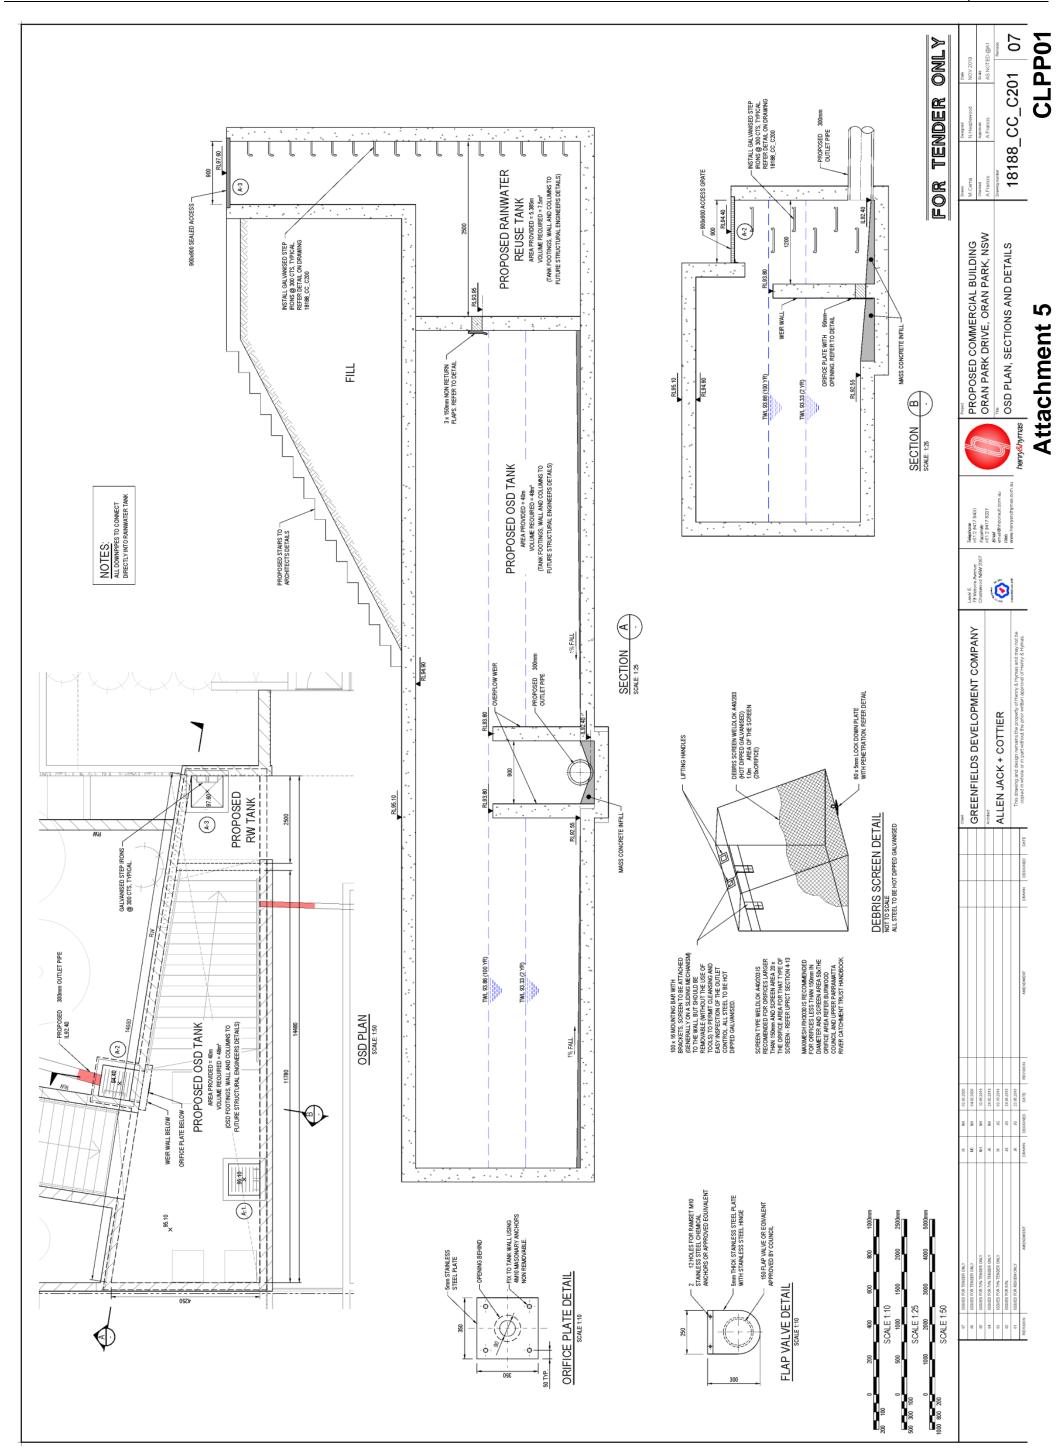
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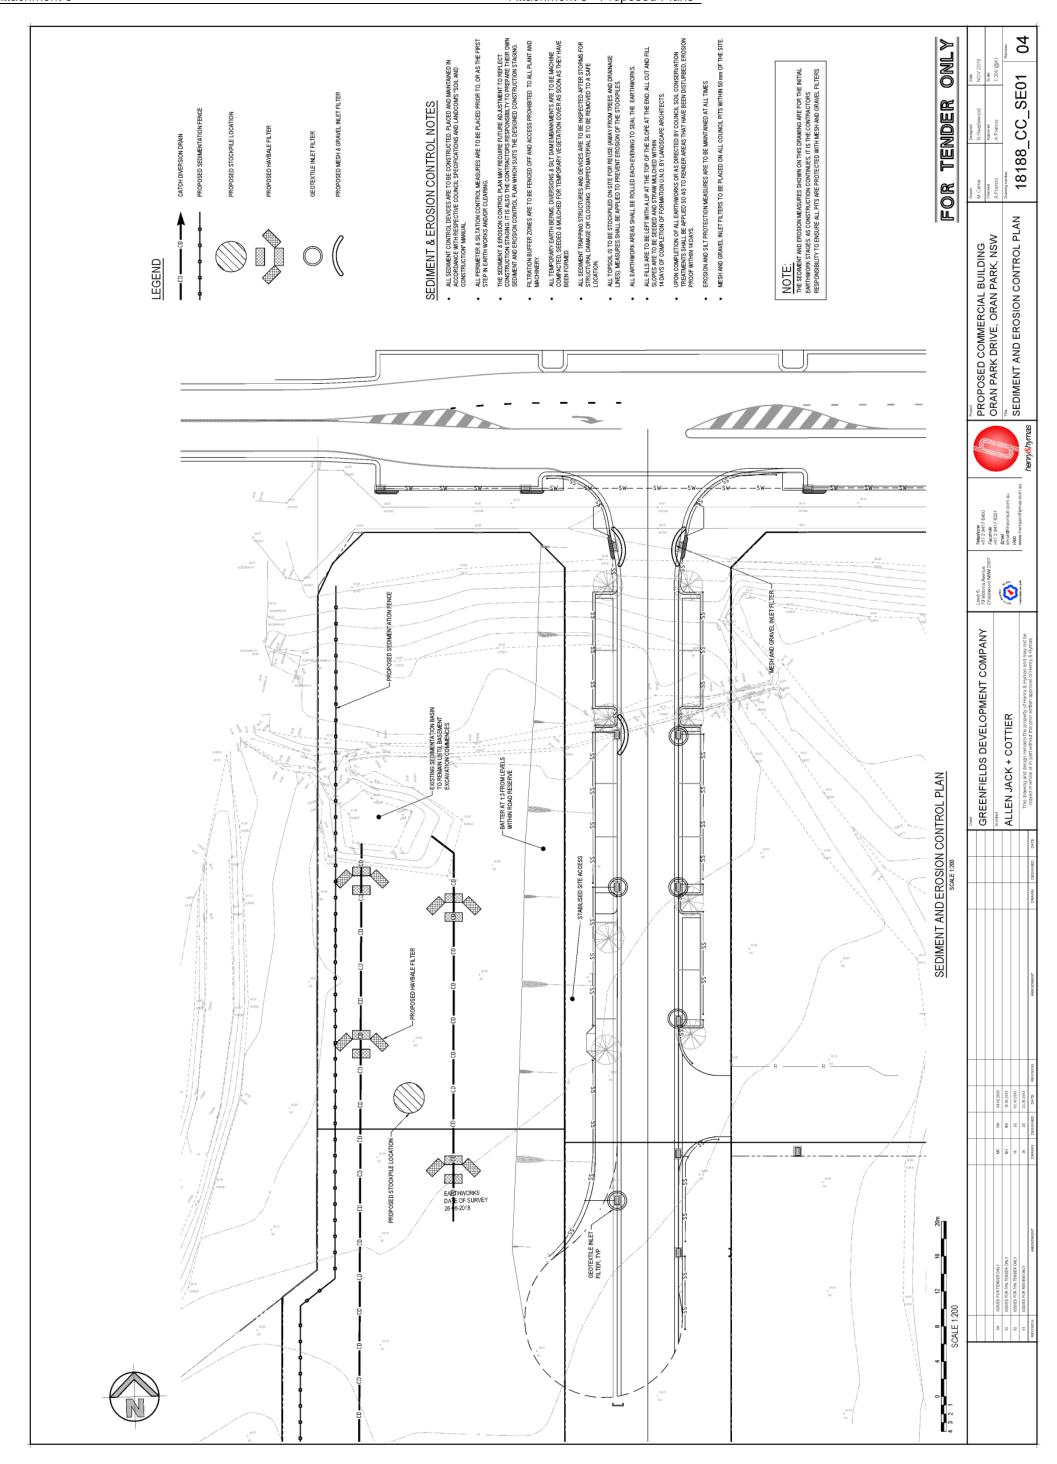


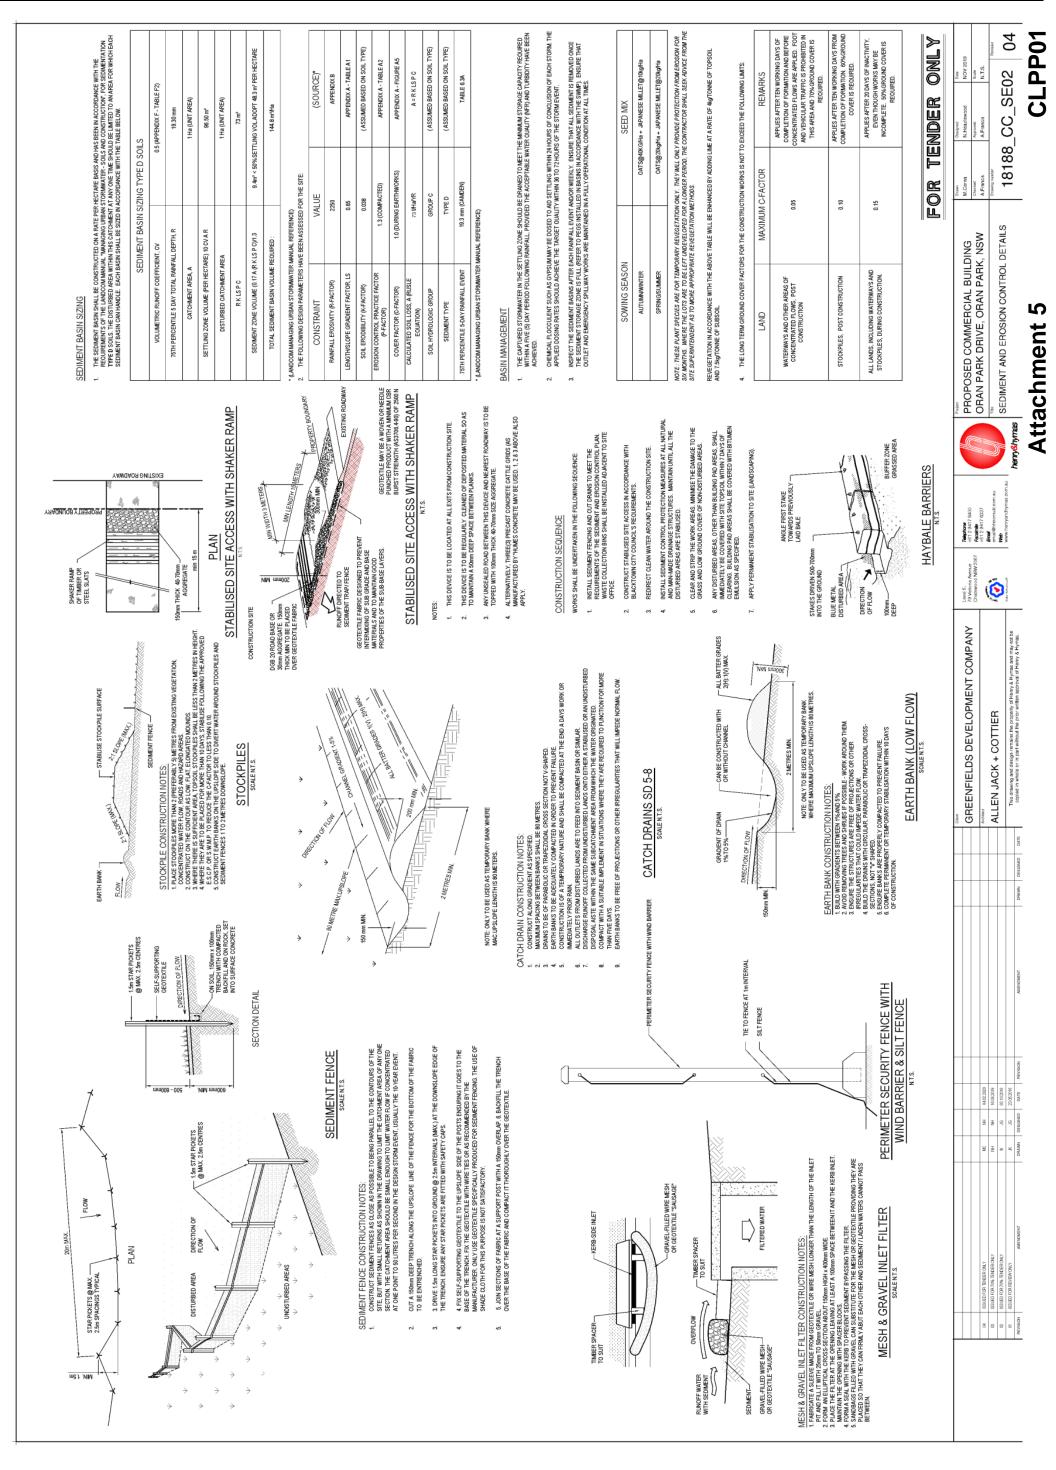




Attachment 5 - Proposed Plans



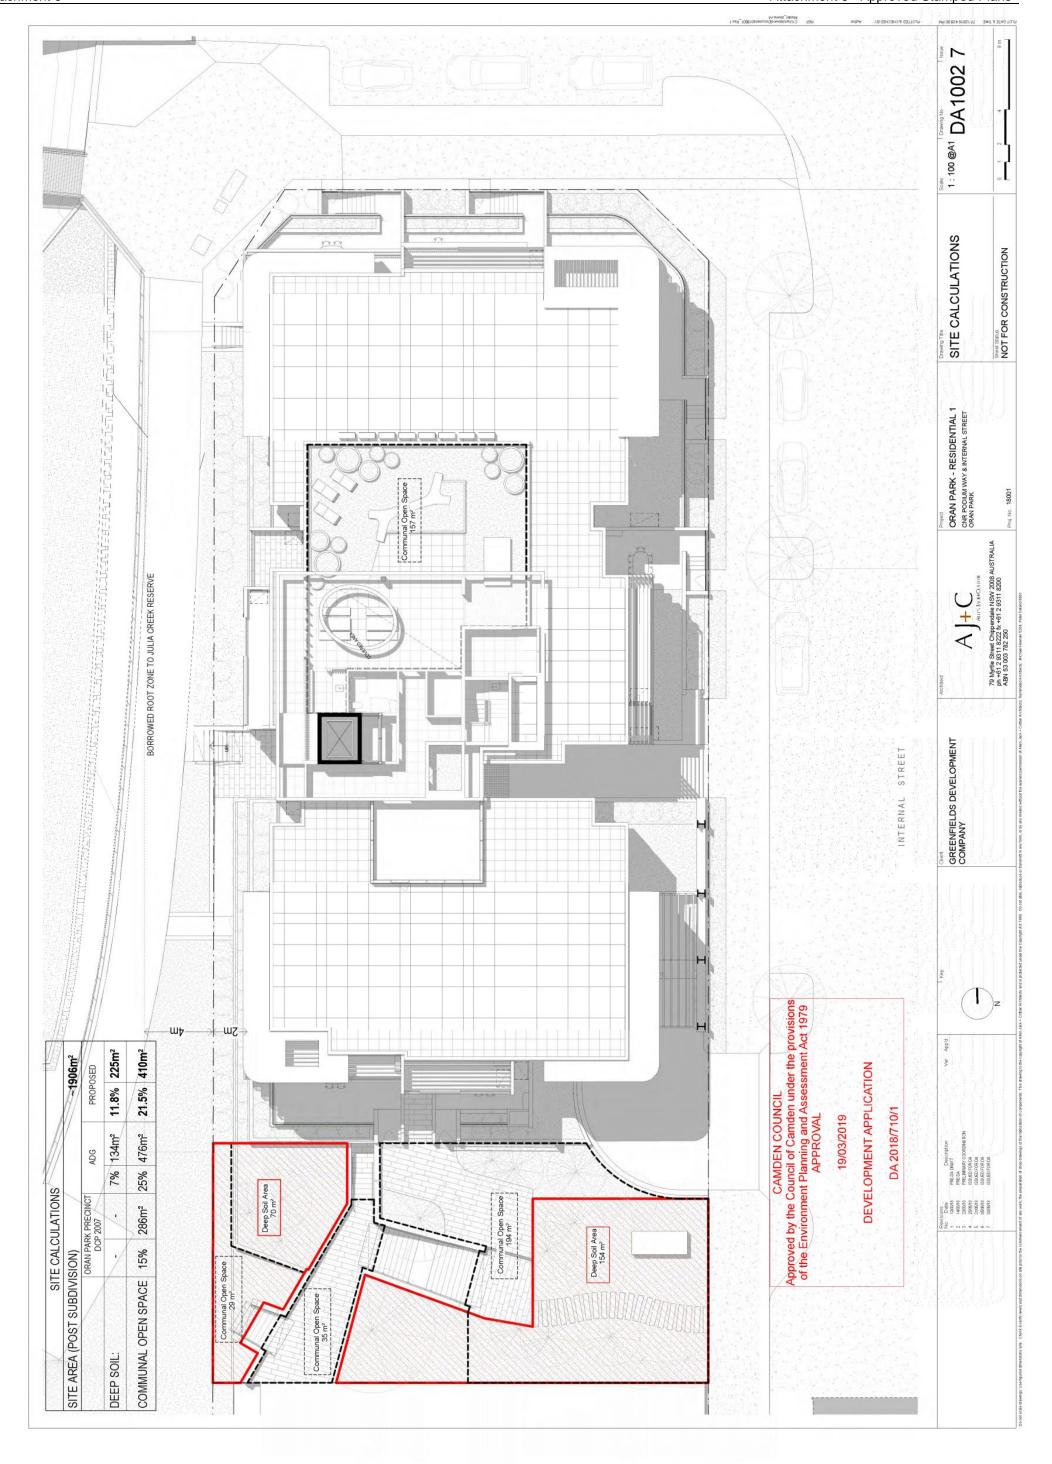


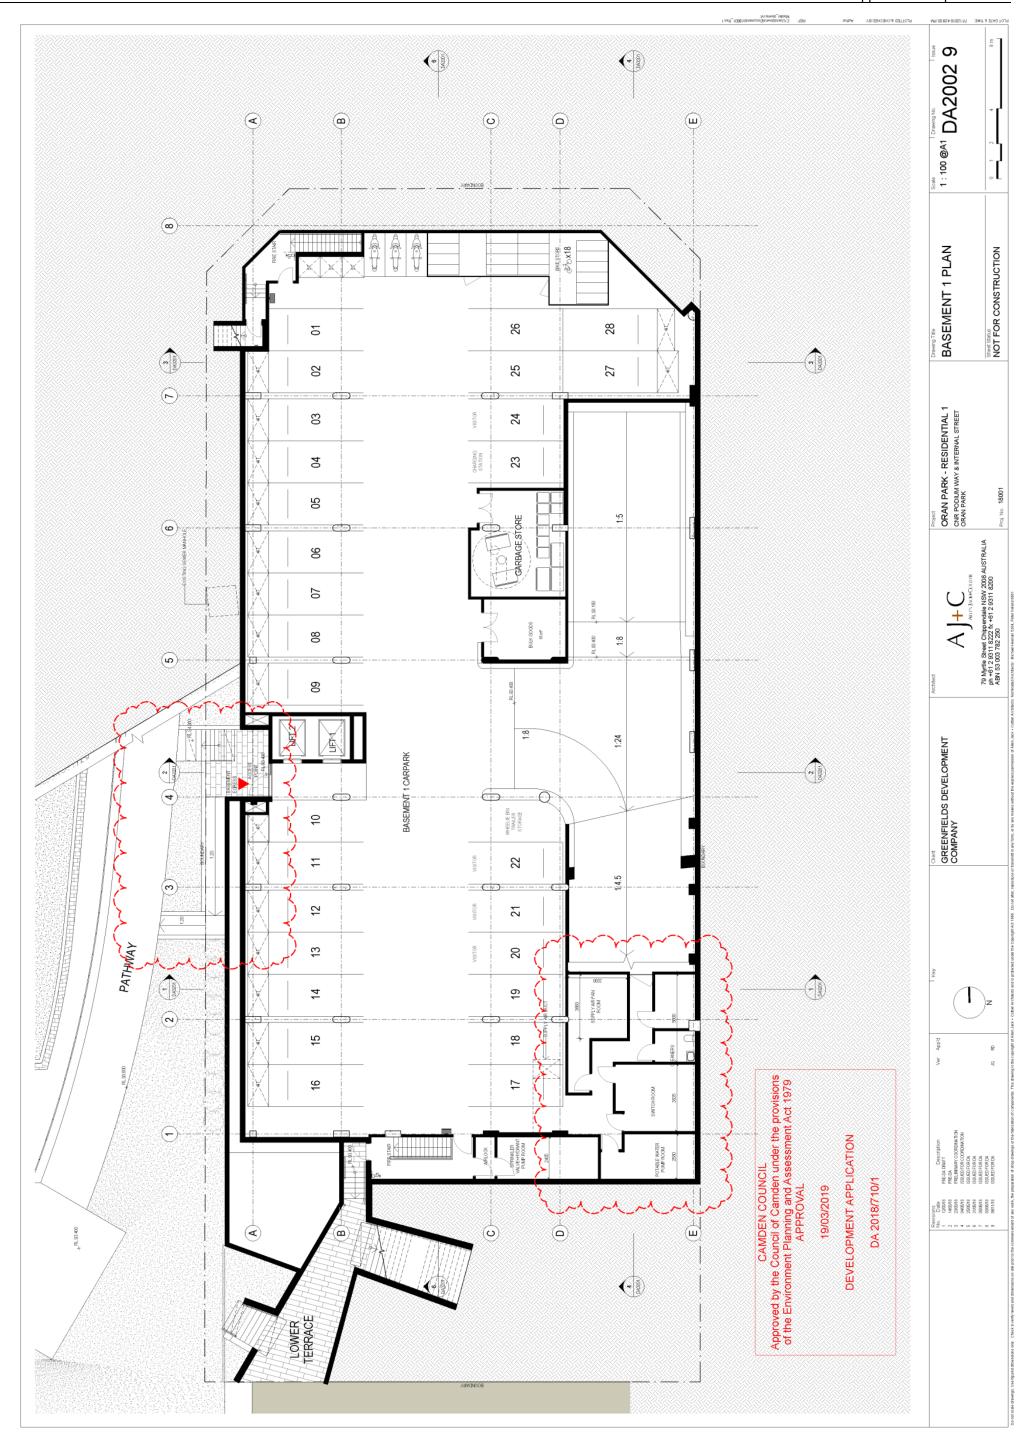


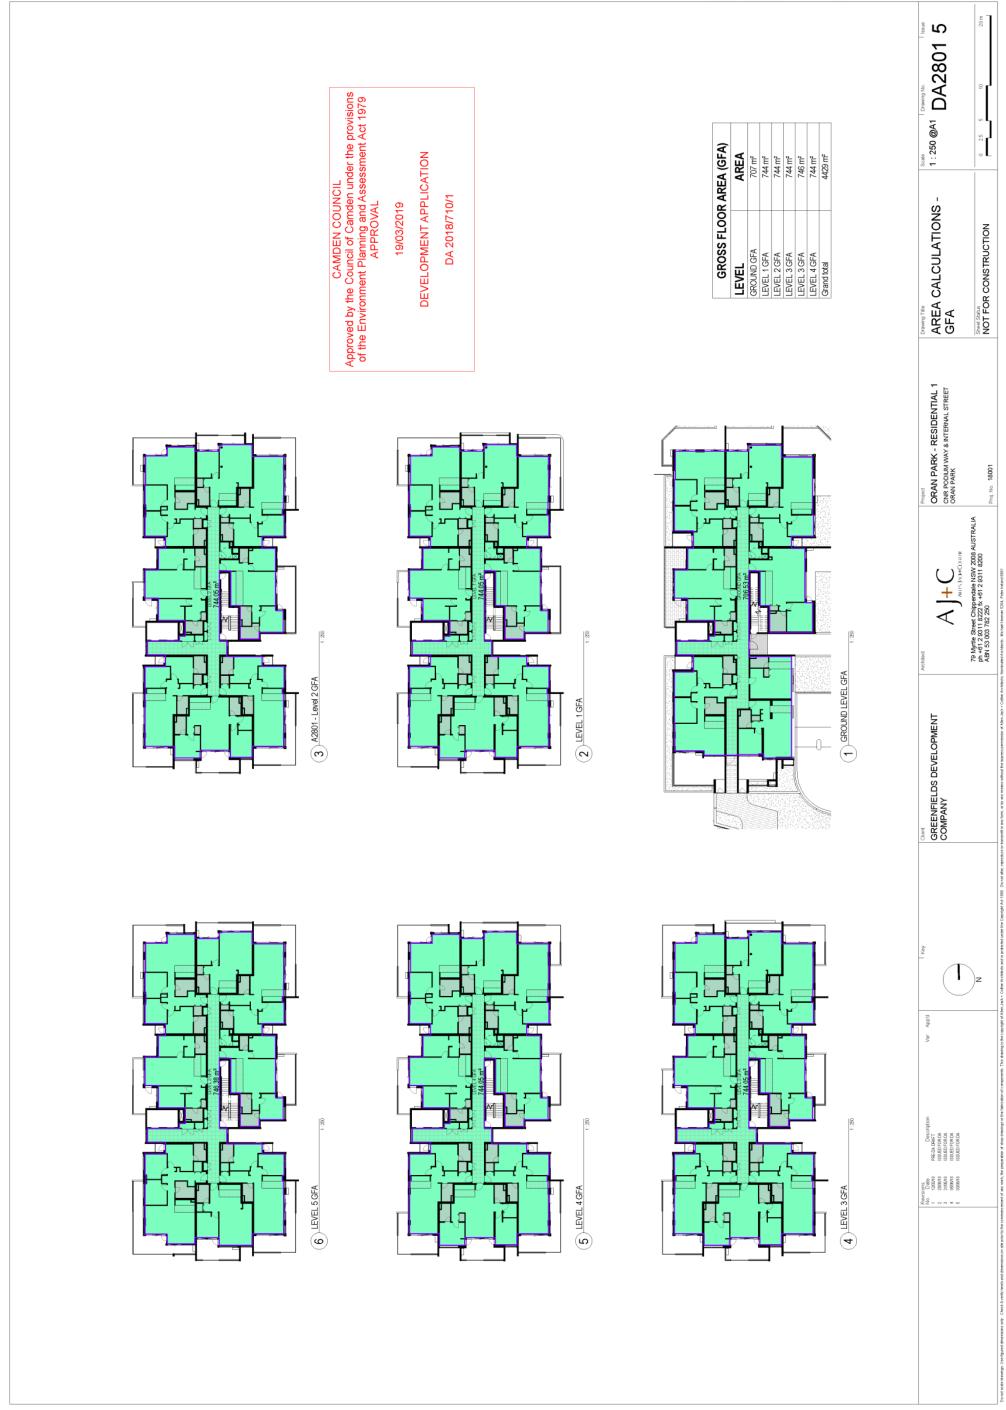


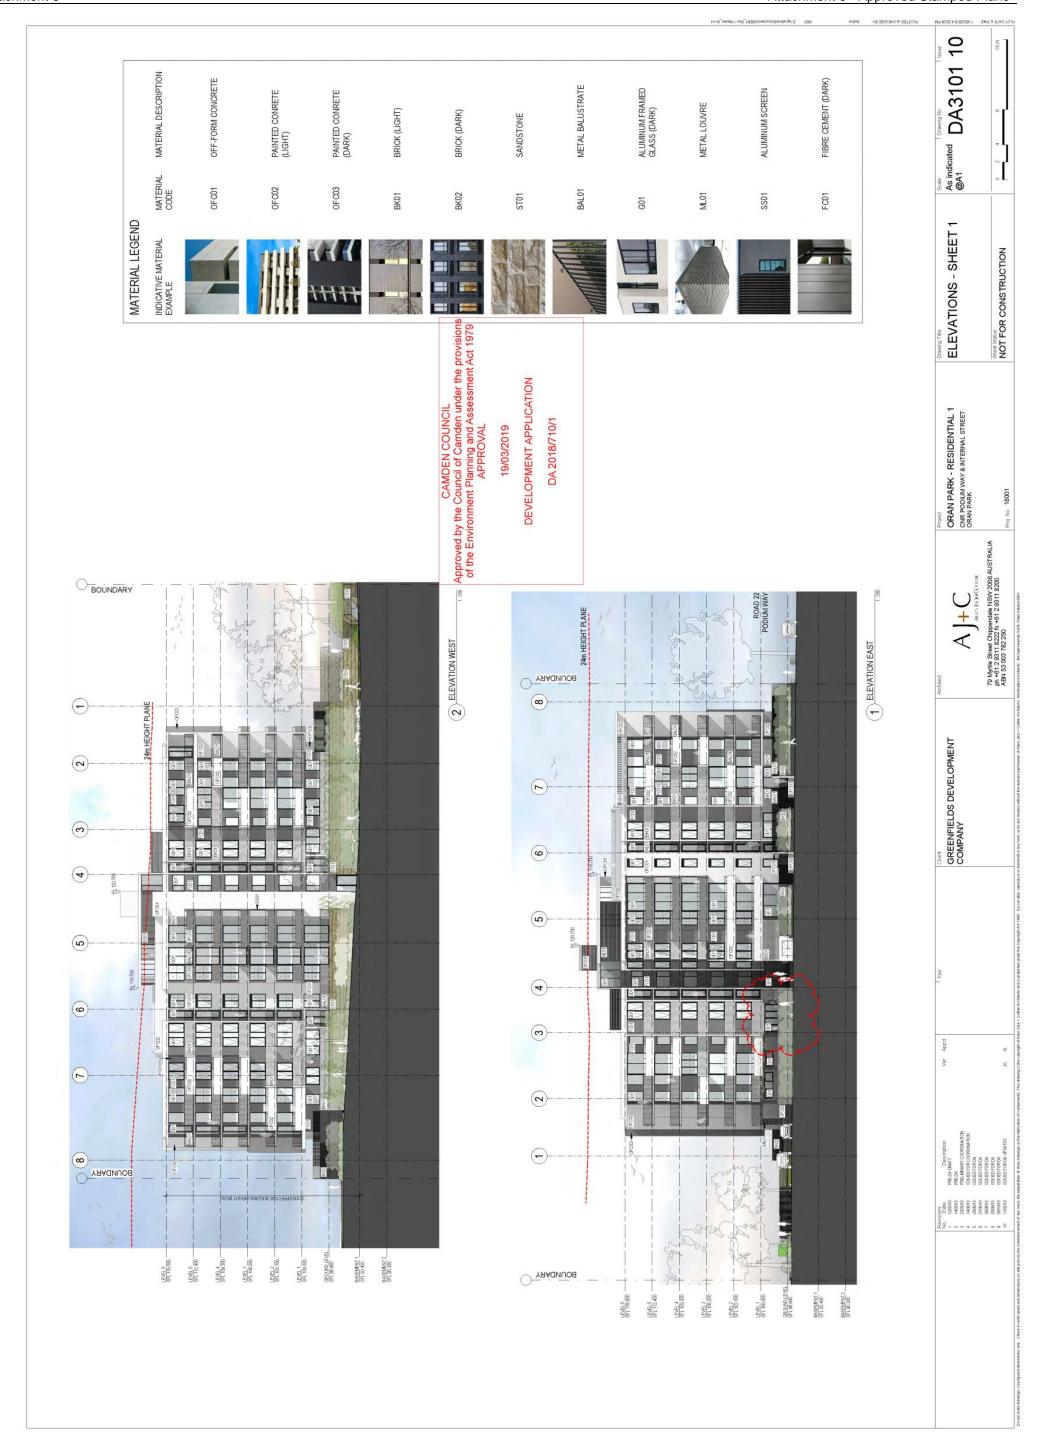
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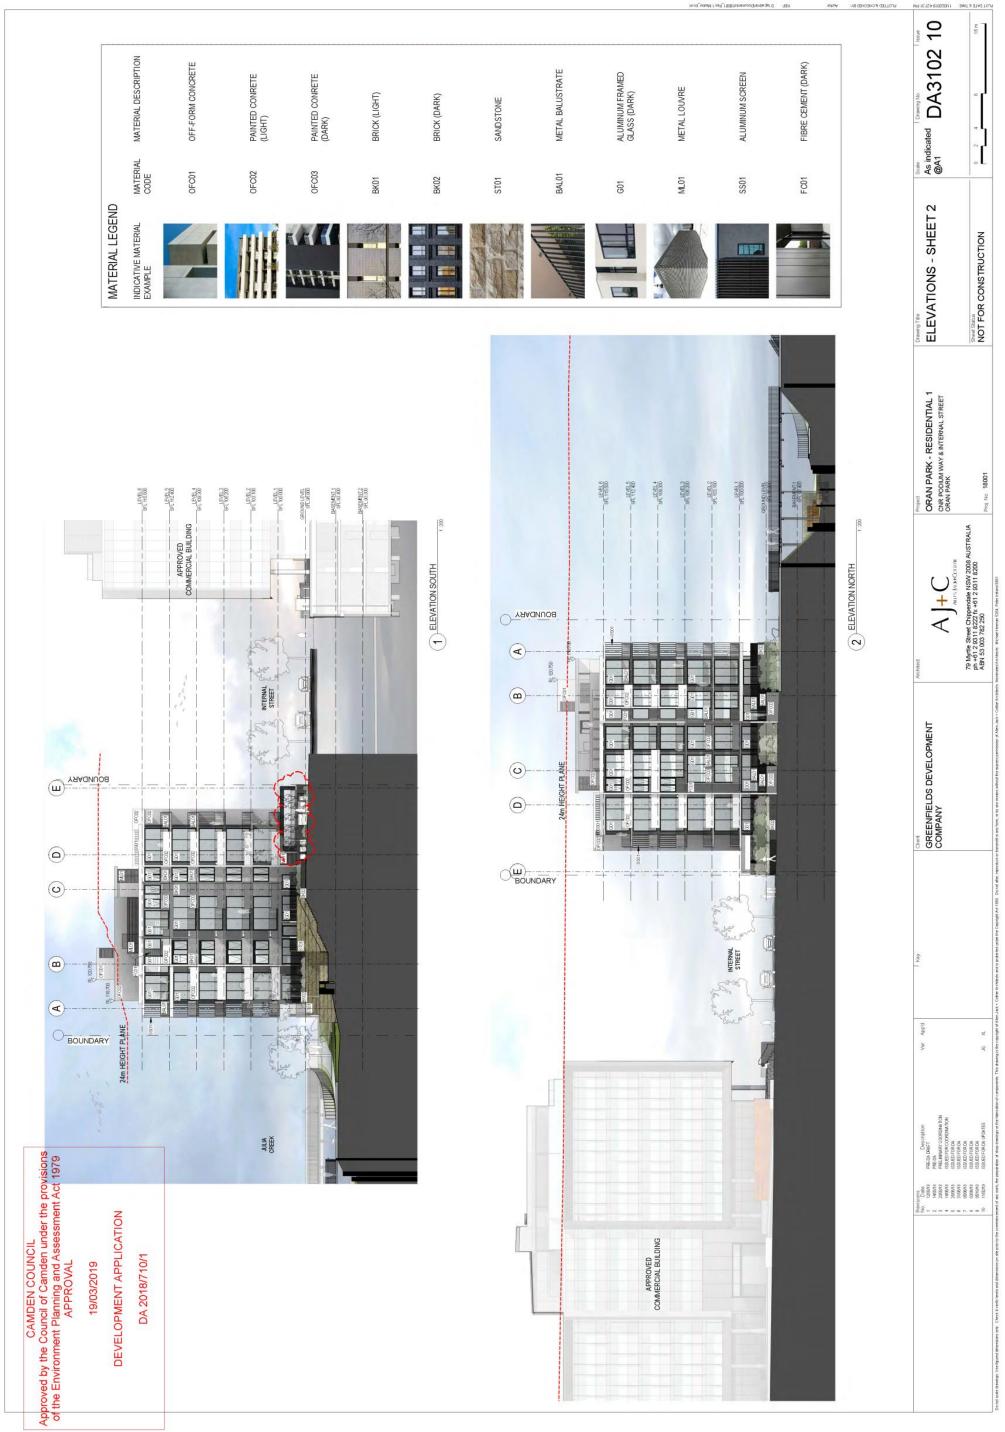
FOOTPATH



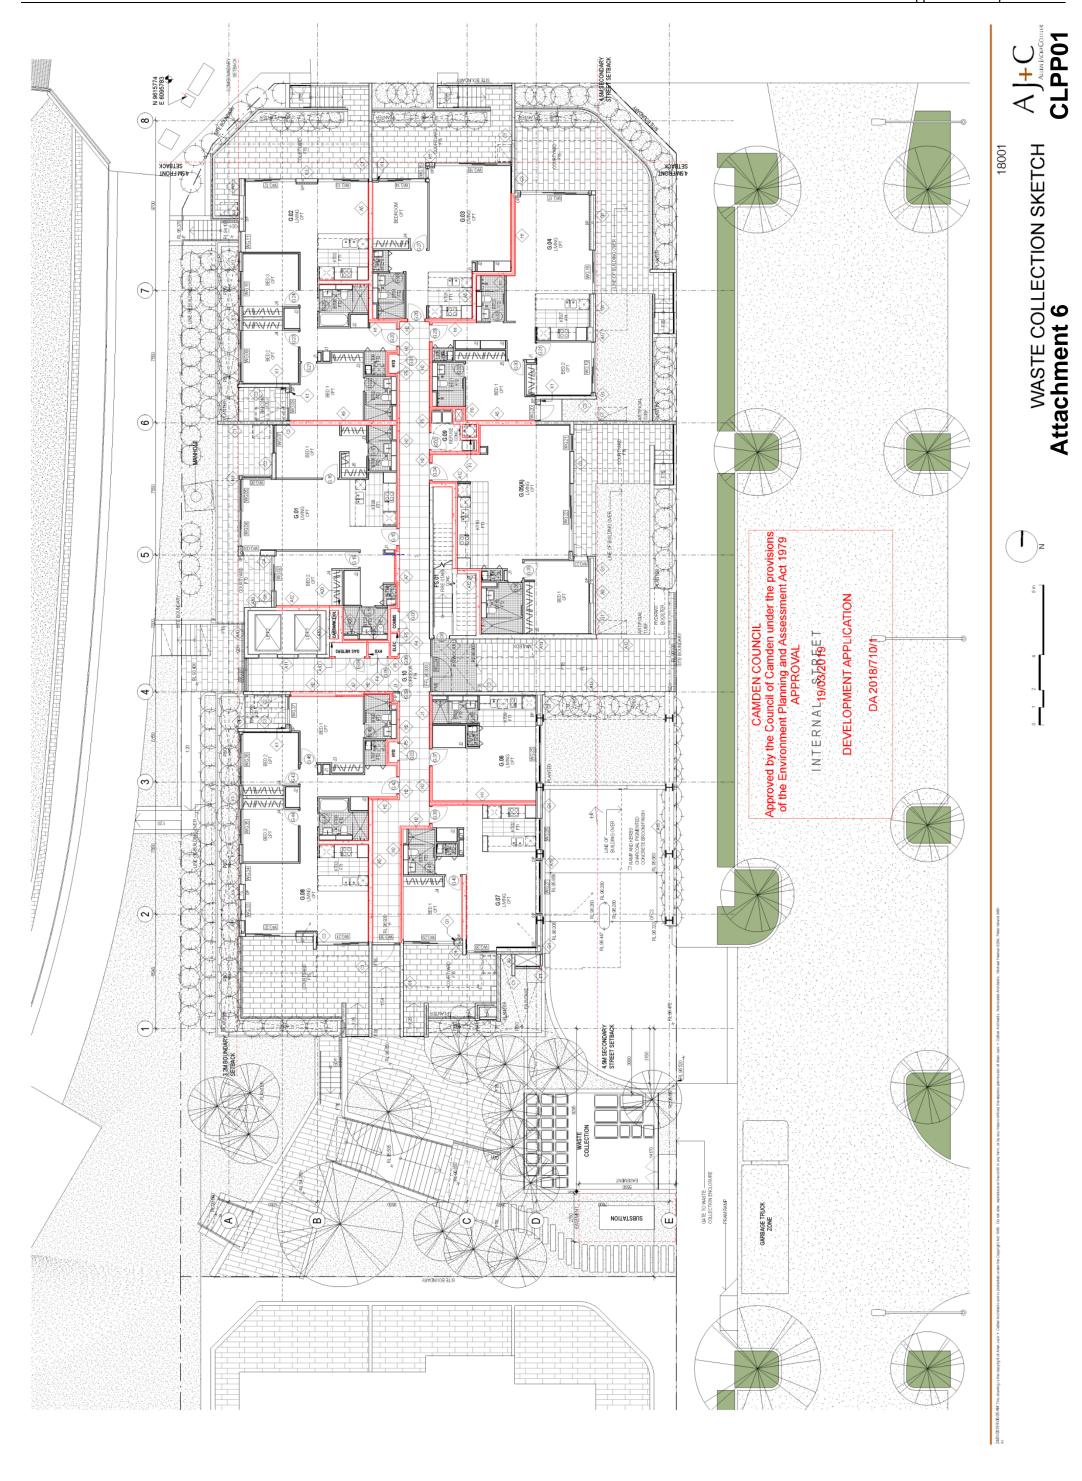












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CAMDEN COUNCIL
Approved by the Council of Camden under the provisions of the Environment Planning and Assessment Act 1979
APPROVAL DEVELOPMENT APPLICATION DA 2018/710/1 19/03/2019















Drawing status
CONSTRUCTION CERTIFICATE

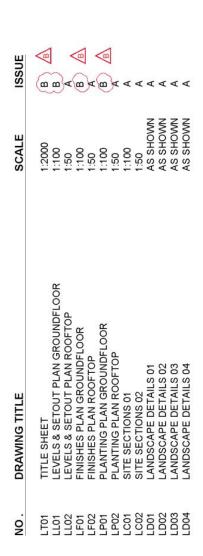
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Lo not scale drawings. Use figured dimensions only. Check & verify le dimensions on site prior to the commencement of any work, the prepar shop drawings or the fabrication of components.

James Delang

# WN TRANCHE 8 RESI 1 ORAN PARK TO **TENDER ISSUE**



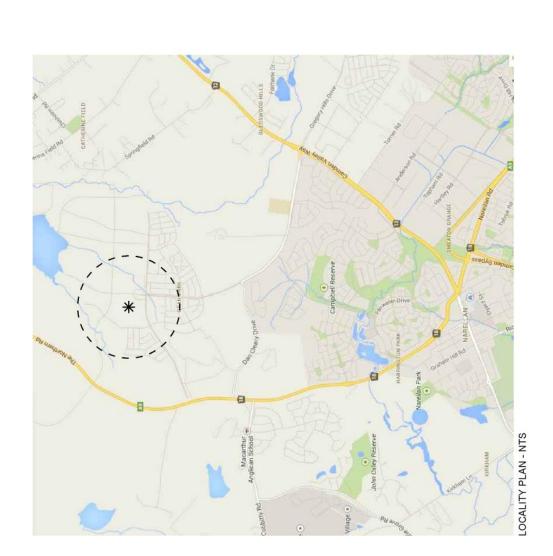


GREENFIELDS
Development Company

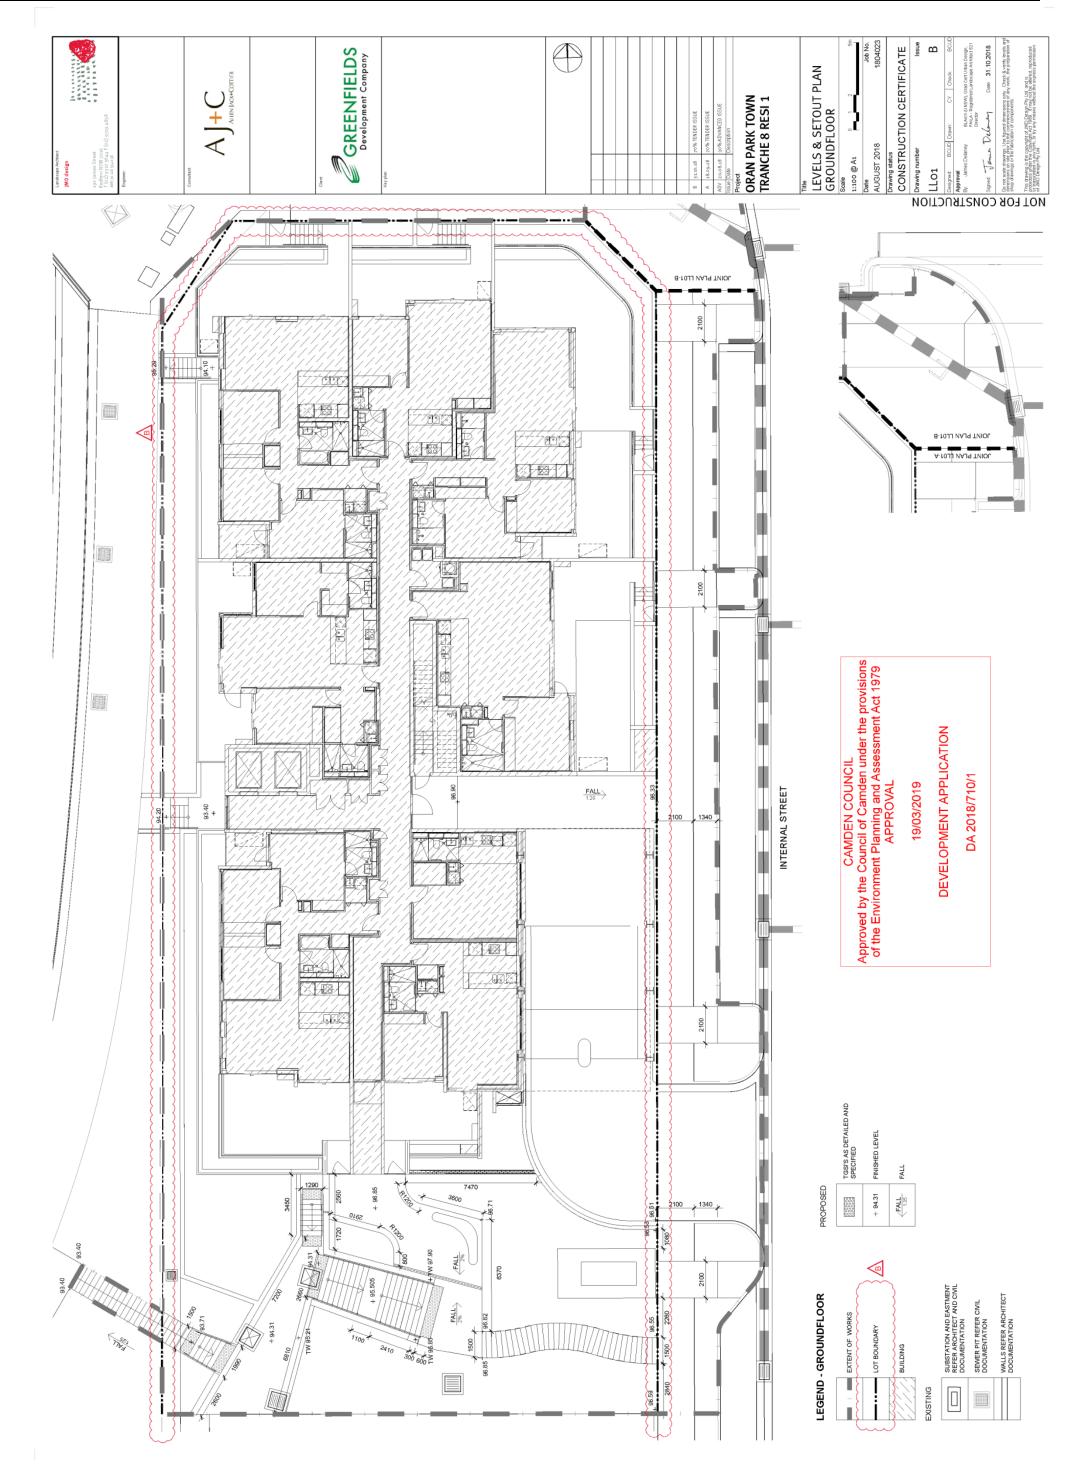


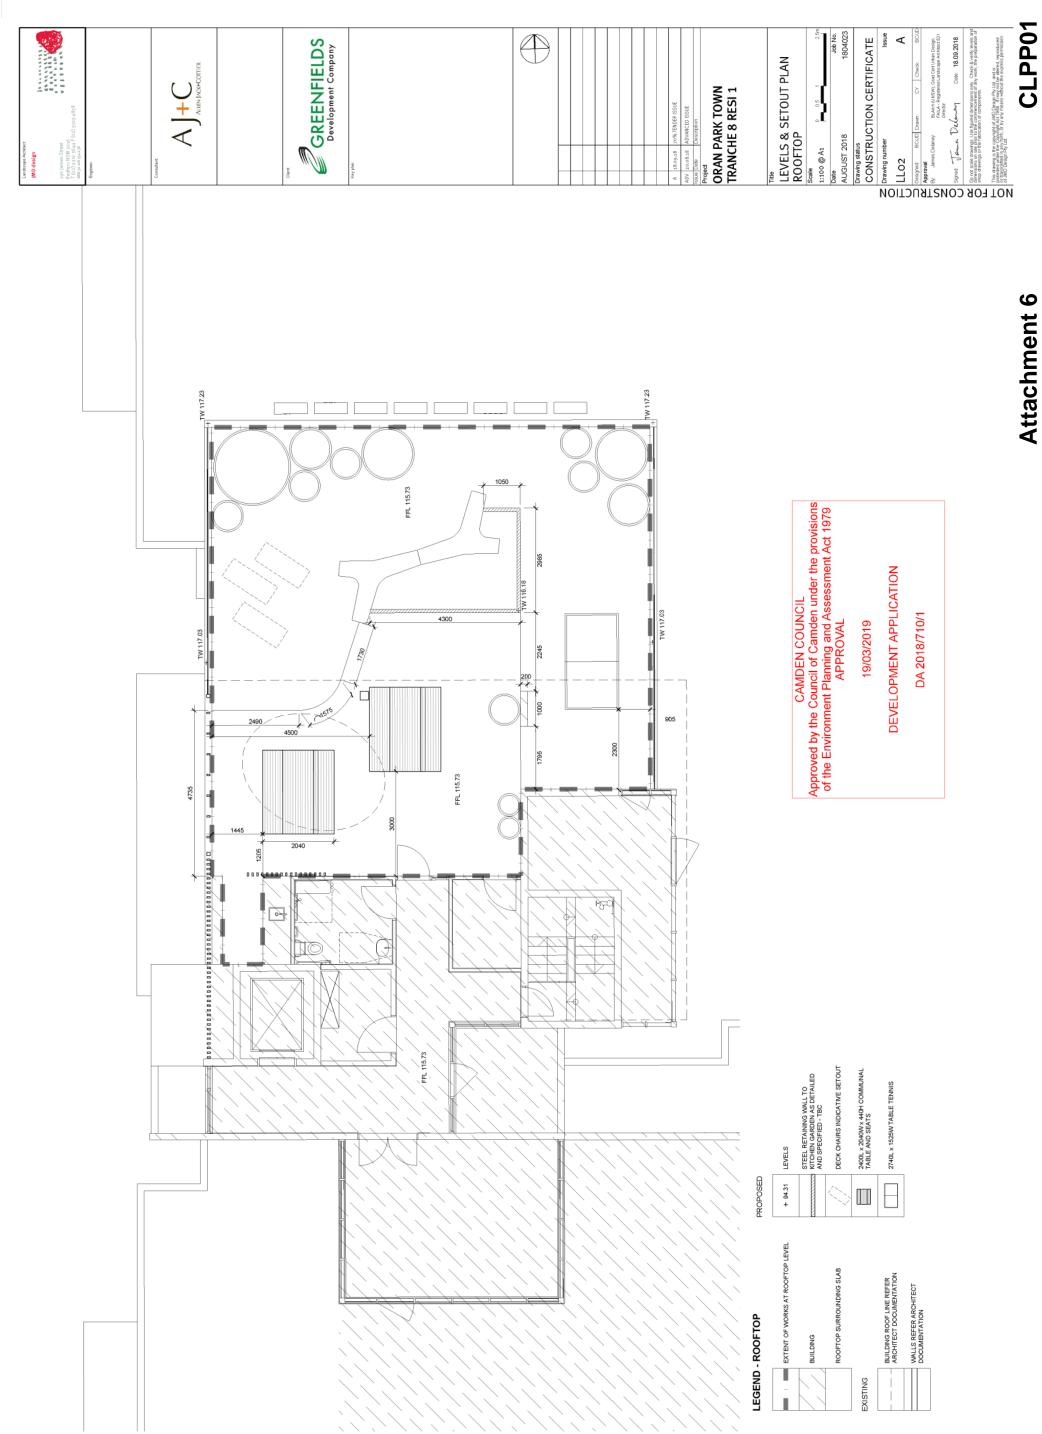
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TITLE SHEET

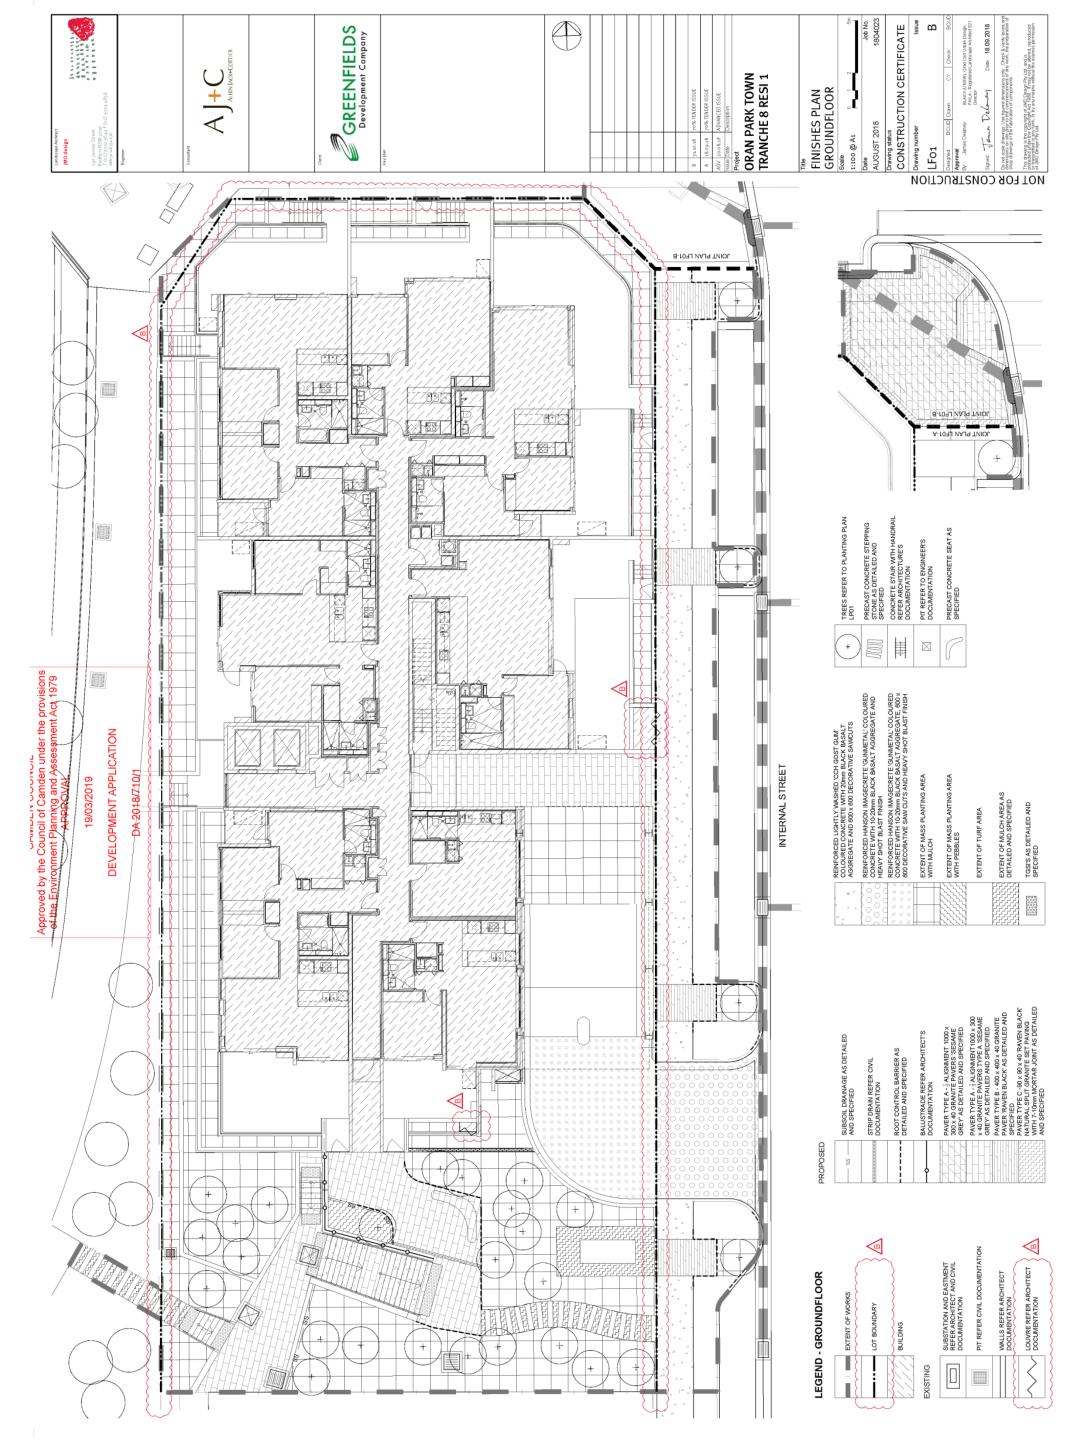


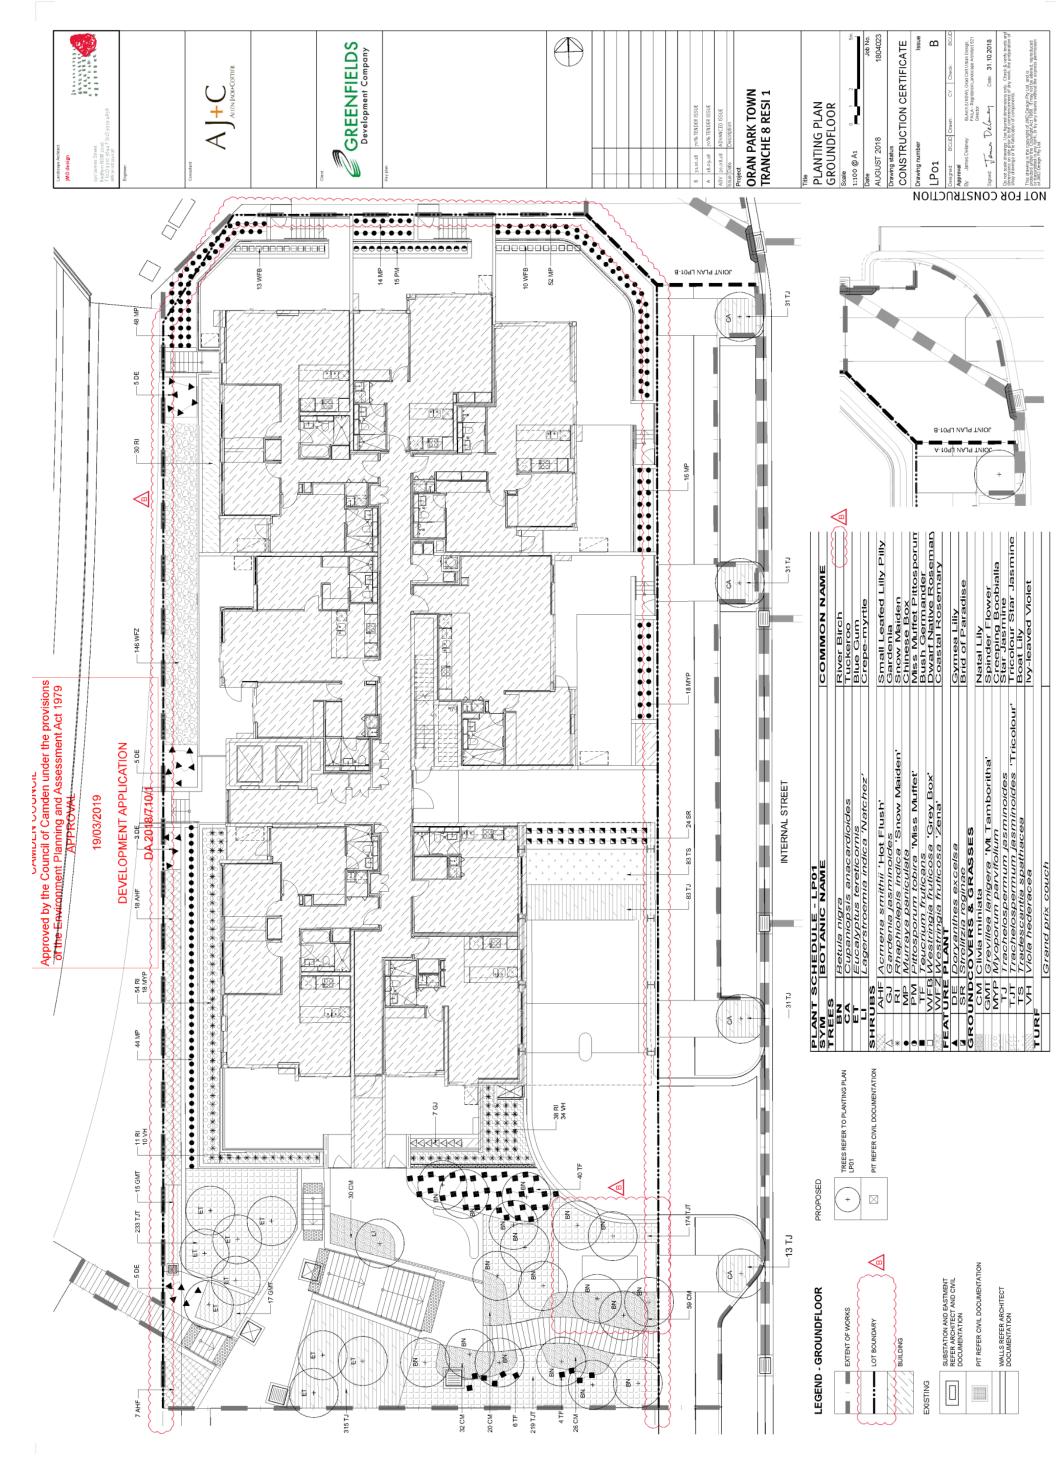


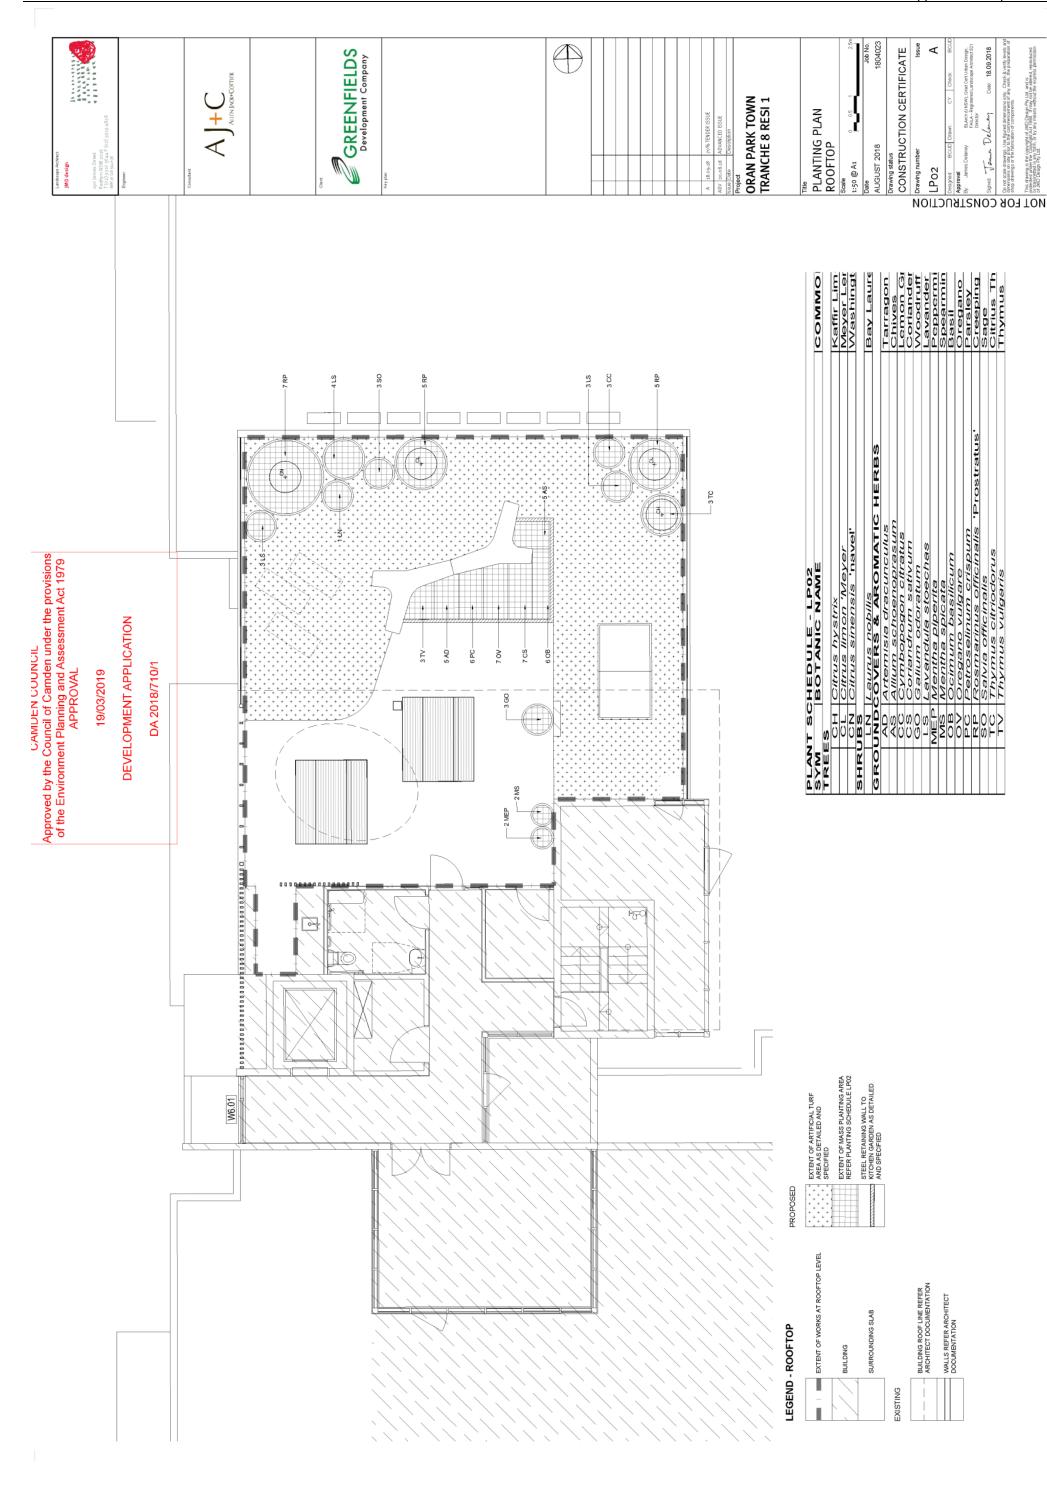


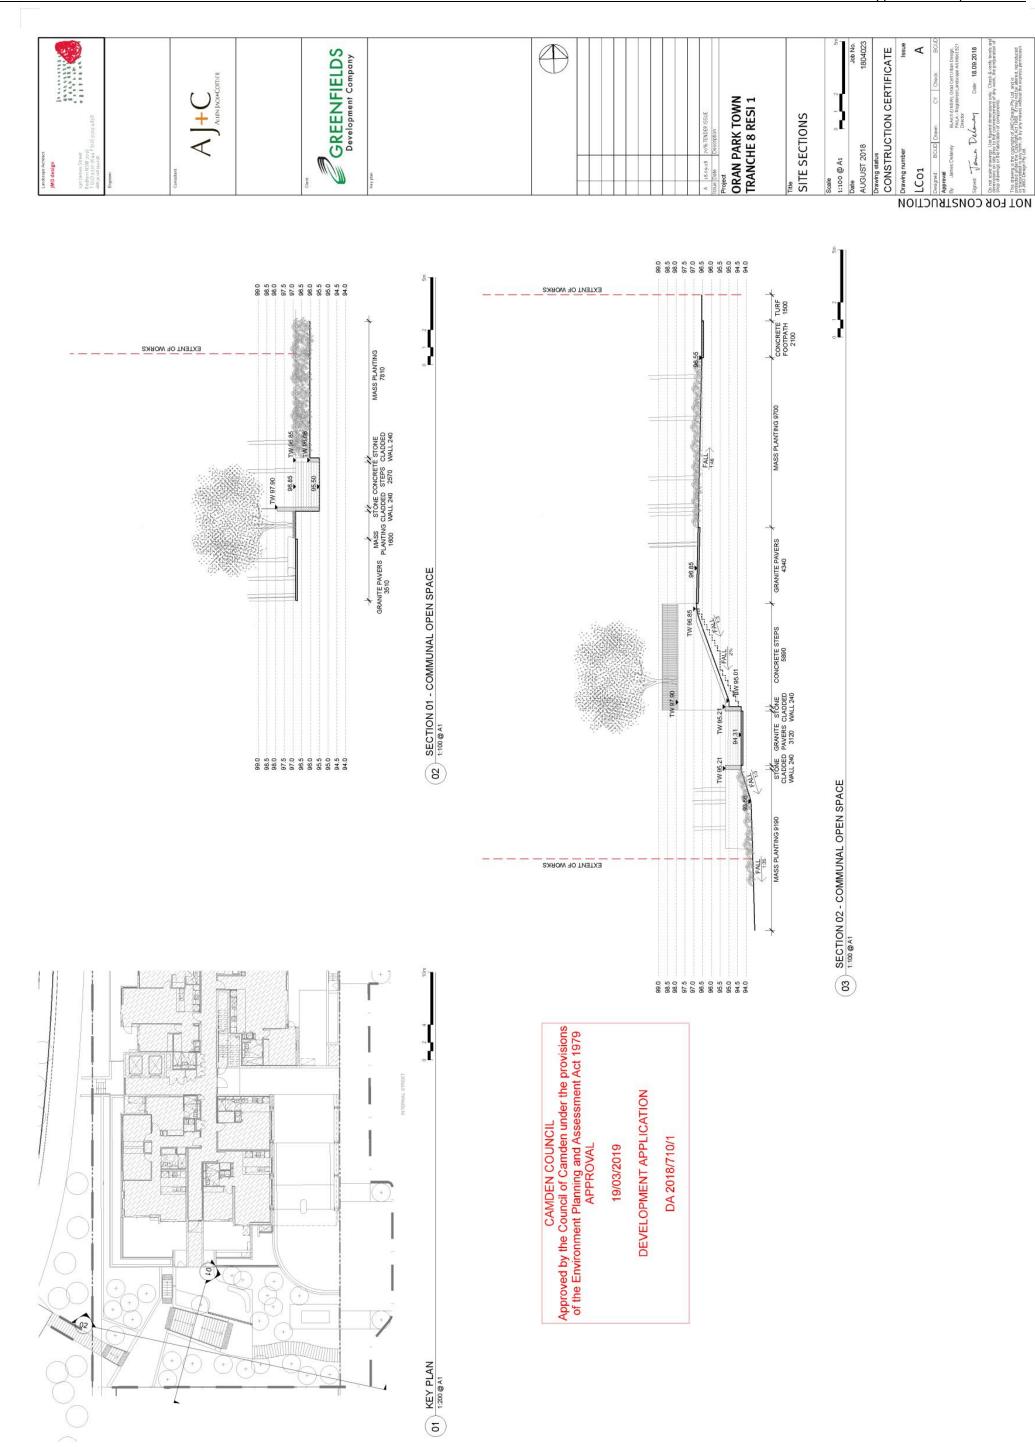


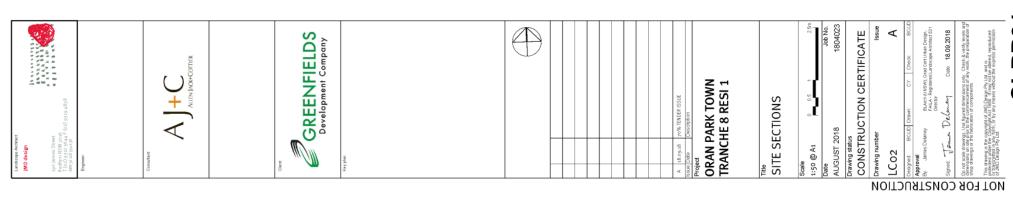


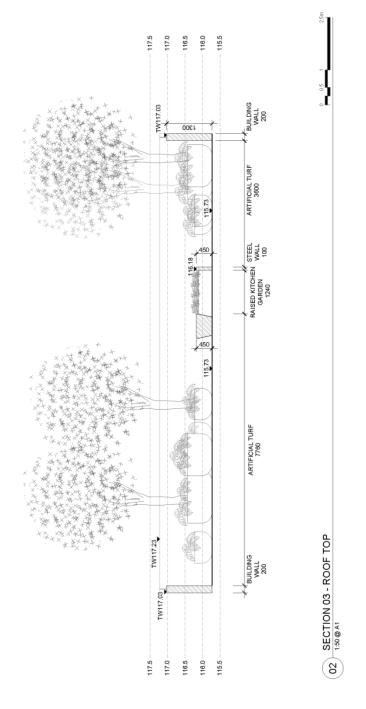




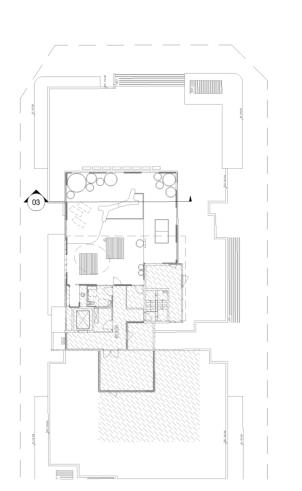


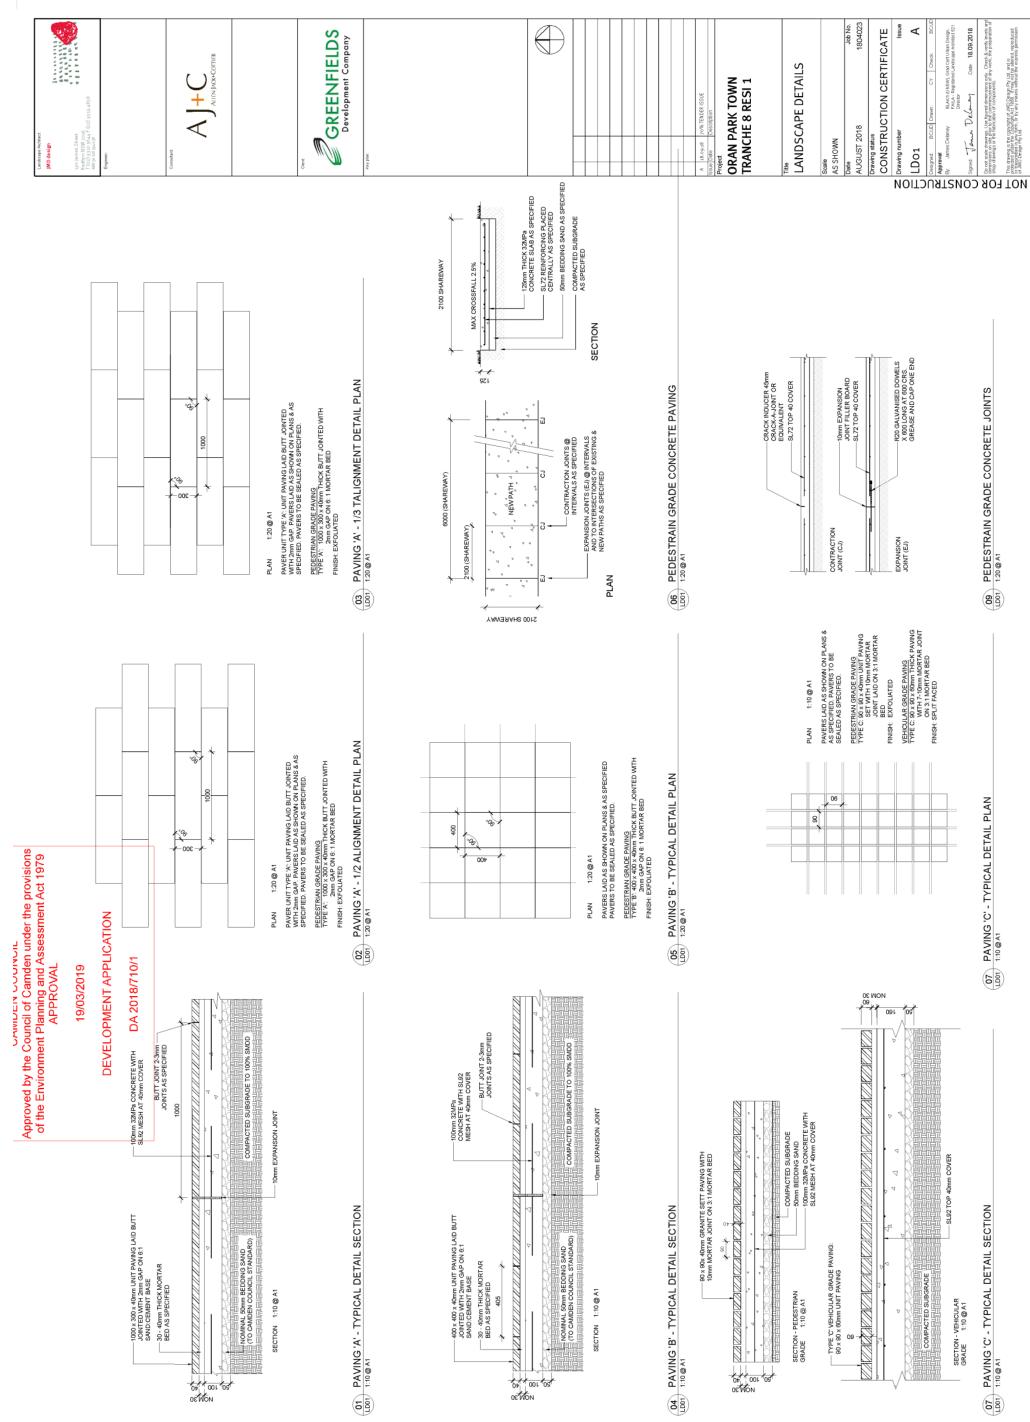


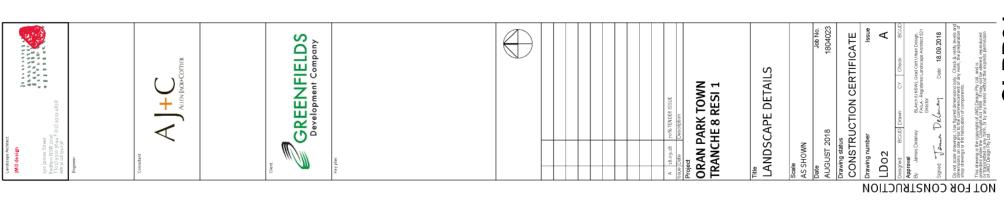


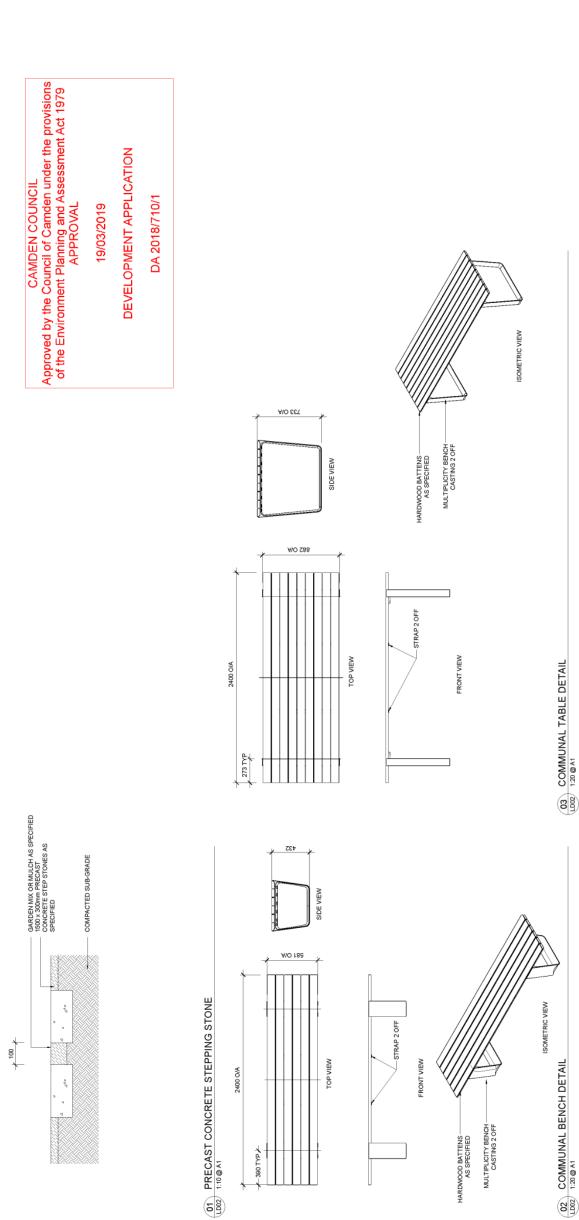


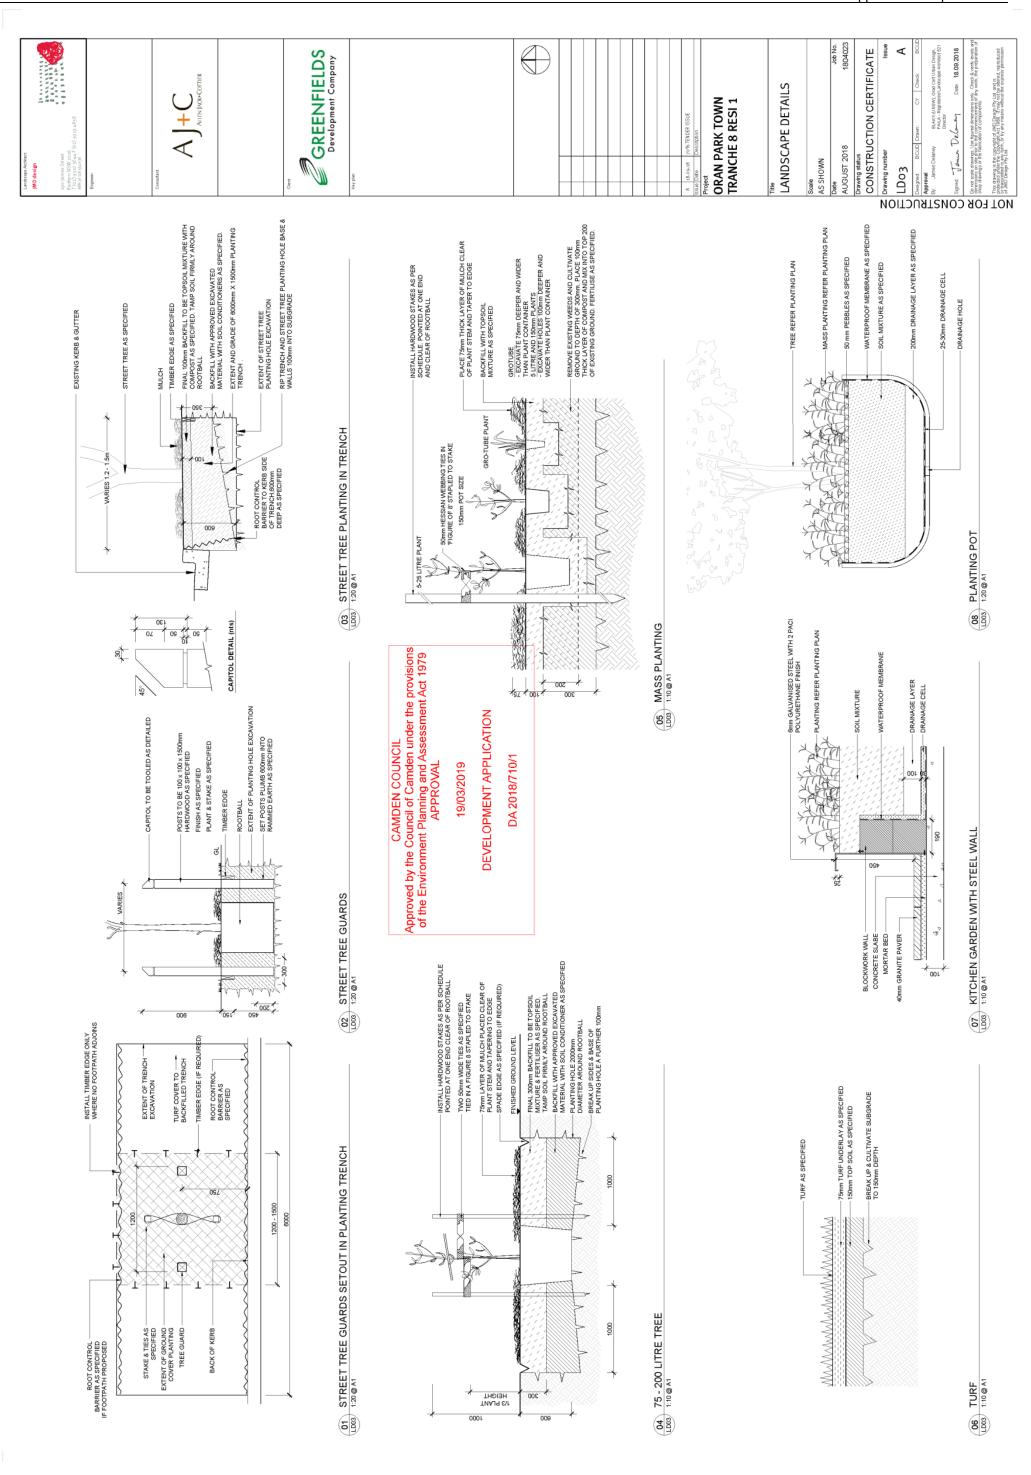
CAMDEN COUNCIL
Approved by the Council of Camden under the provisions of the Environment Planning and Assessment Act 1979
APPROVAL
19/03/2019
DEVELOPMENT APPLICATION
DA 2018/710/1

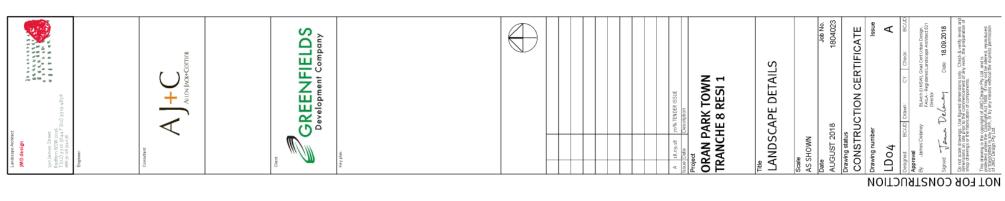




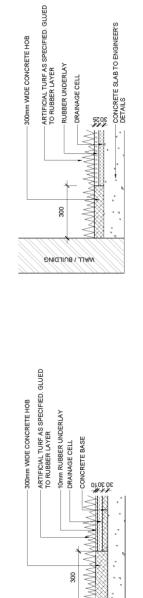


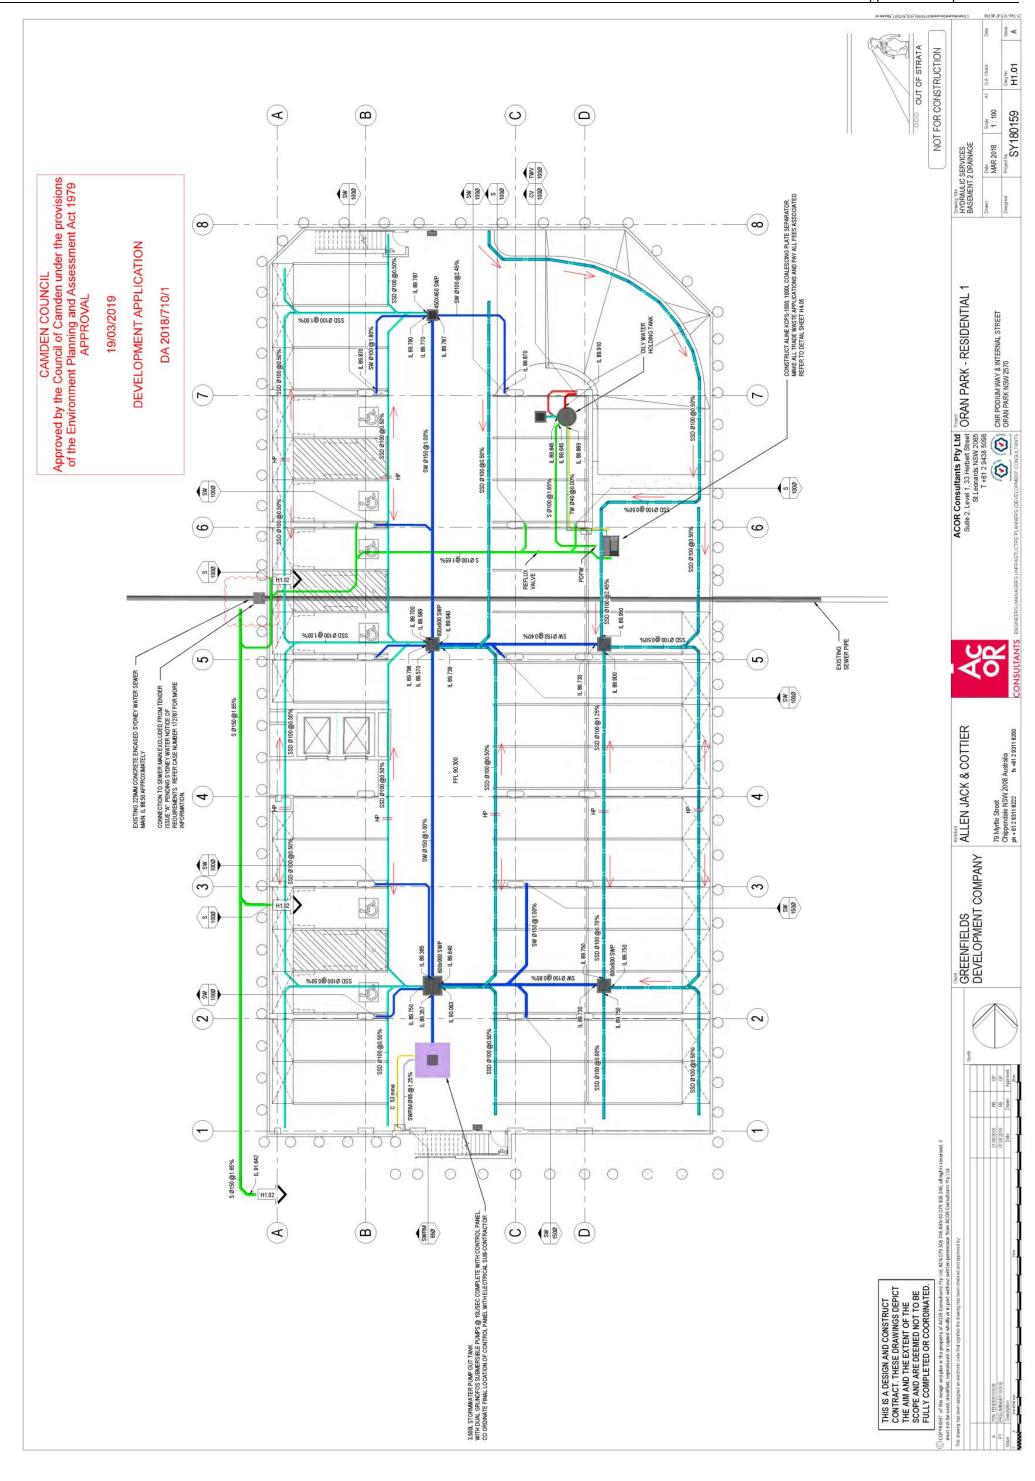


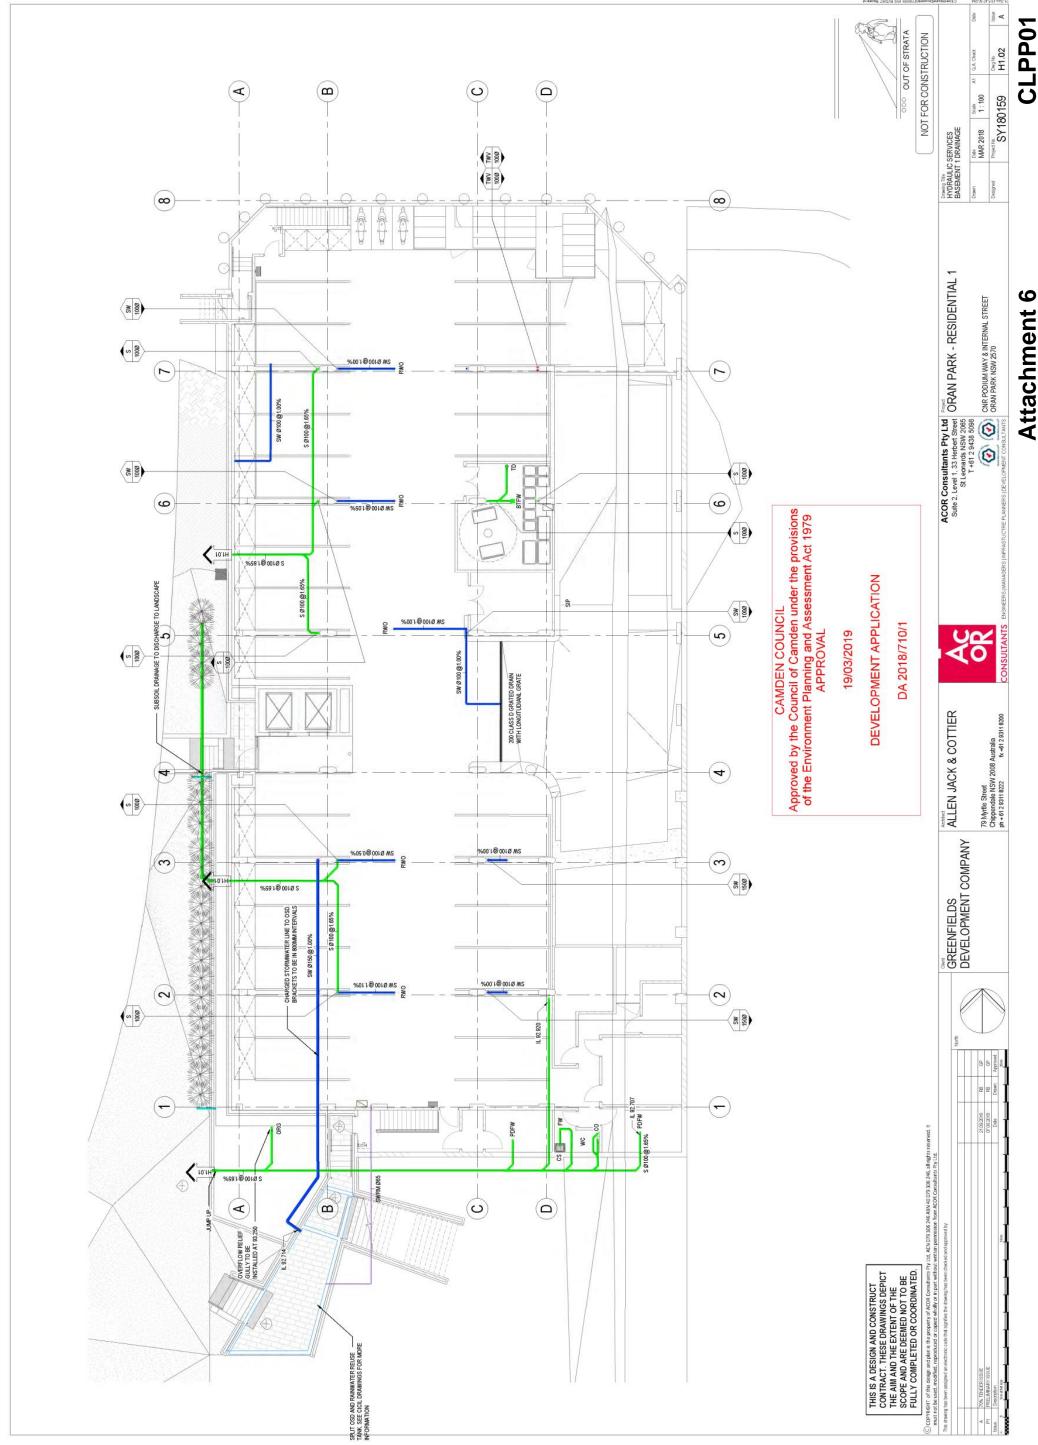


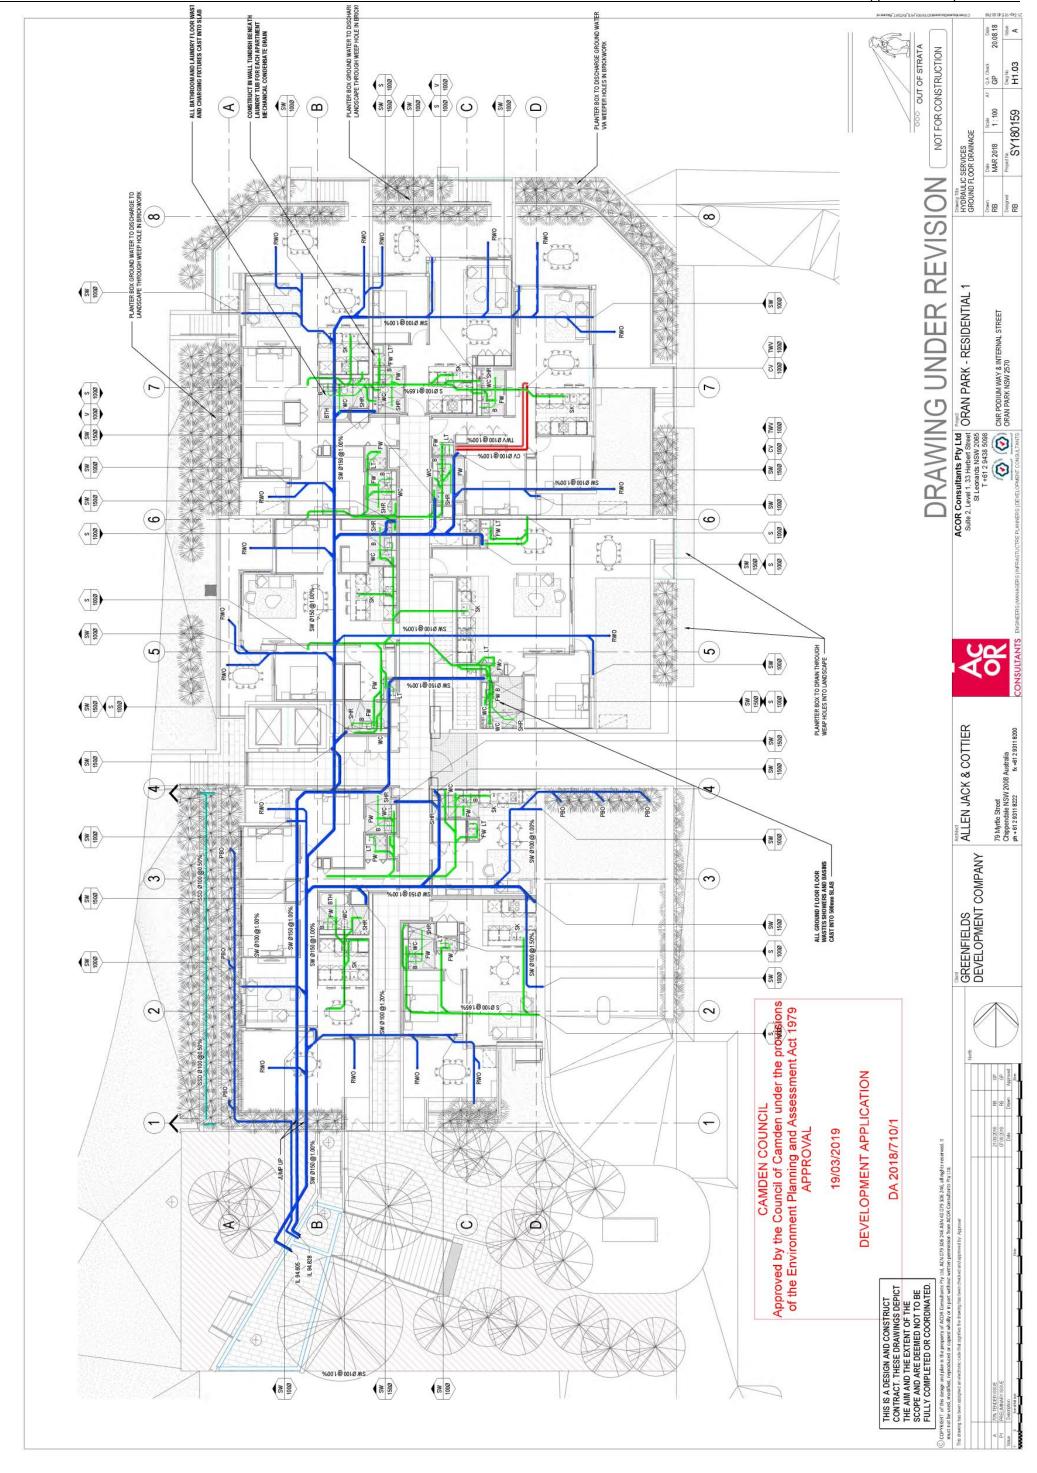


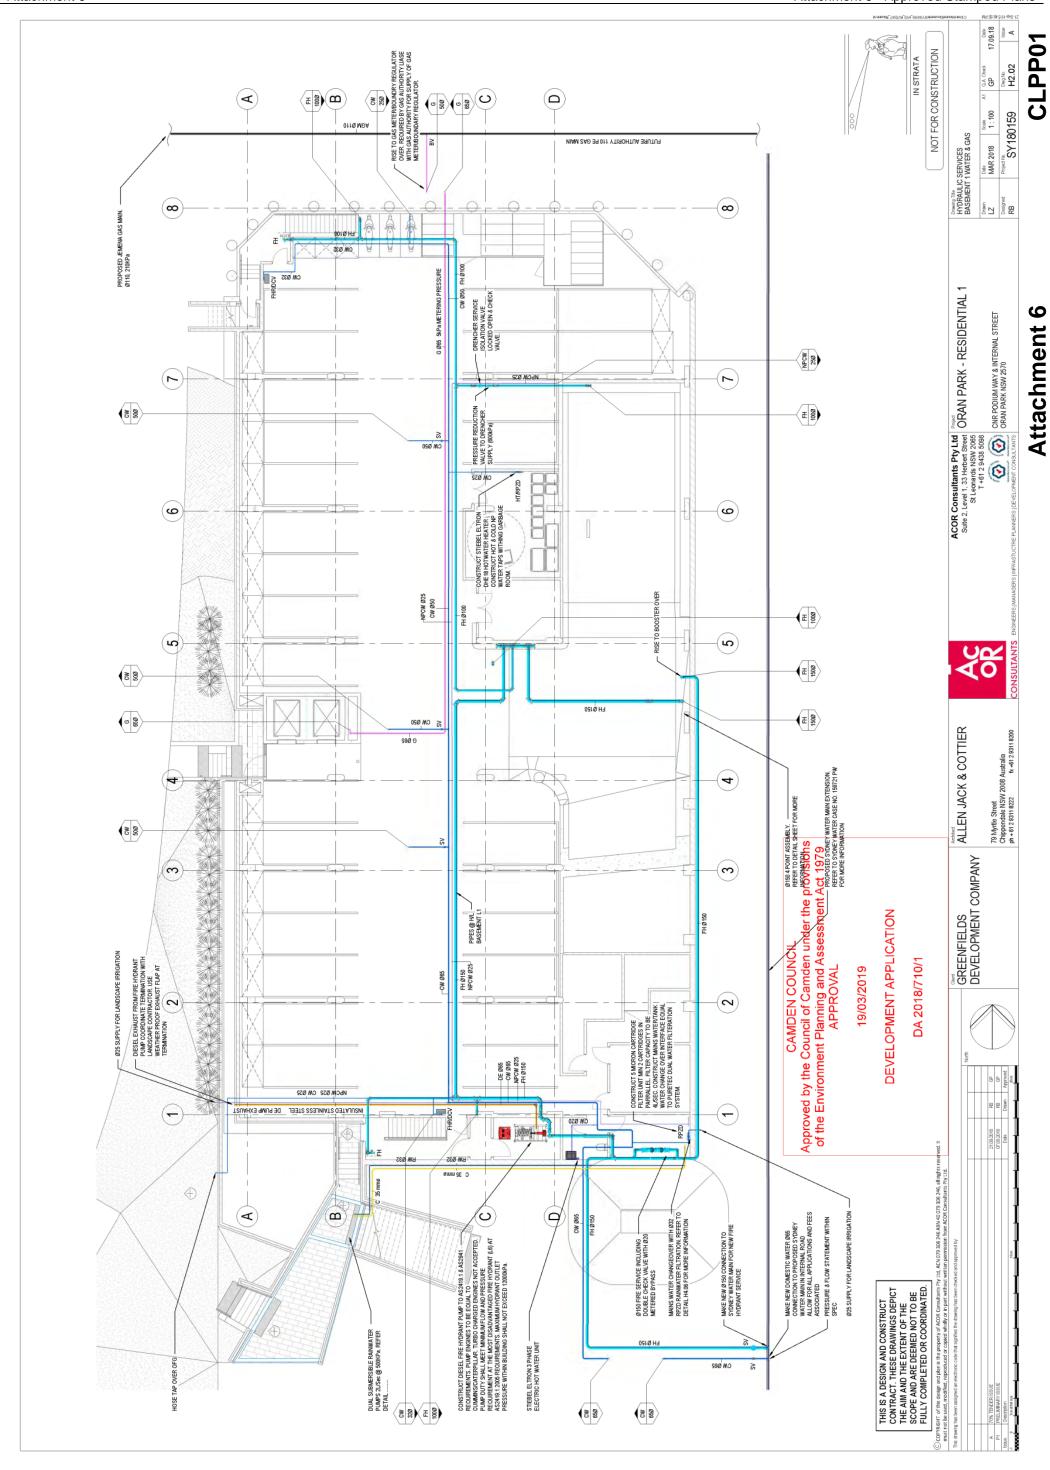












# ORAN PARK DRIVE, ORAN PARK NSW PROPOSED RESIDENTIAL BUILDING CIVIL ENGINEERING WORKS

### GENERAL NOTES

- NCIL'S AIN A COPY ON SITE
- CONDITIONS AND ALL NEW WORKS ARE TO MAKE A SMOOTH JUNCTION WITH EXIST MARRY IN A "WORKMANLIKE" MANNER.
- MAINTAINED IN SERVICES & ACCESSES TO THE EXISTING PROPERTIES ARE TO BE I WORKING ORDER AT ALL TIMES DURING CONSTRUCTION.
- TO RELEVANT
  - ADJUST EXISTING SERVICE COVERS TO SUIT NEW FINISHED LEVELS AUTHORITY REQUIREMENTS WHERE NECESSARY.
- REINSTATE AND STABILISE ALL DISTURBED LANDSCAPED AREAS
- MINIMUM GRADE OF SUBSOIL SHALL BE 0.5%(1:200) FALL TO OUT
- TO BE CONSTRUCTED, PECIFICATIONS, ICIL'S REQUIREMENTS
- ONS ACROSS THE
- ANCE WHERE

### SITEWORKS NOTES

HERE

- S ON SITE CONTRACTOR MUST VERIFY ALL DIMENSIONS AND EXISTING LEVE PRIOR TO THE COMMENCEMENT OF WORK.
- LS SHOWN ALL WORKS TO BE UNDERTAKEN IN ACCORDANCE WITH THE ON THE DRAWINGS & THE DIRECTIONS OF THE SUPERINTENI
- ENSTING SERVICES UNLESS SHOWN ON THE SURVEY PLAN HAVE BEEN PUTITER PROVISENCE NAMES SERVICES SHOWN ON THE SURVEY PLAN HAVE BEEN PUTITER PROVISE PROSED HAS SUGHT HER ACCURACY CANNOT BE GUARANTEED. IT IS THE RESPONSIBILITY OF THE CONTRACTOR TO THE COMMENCEBARIO TO THE FEBRO OF THE SURVEYING SERVICES PRIOR TO THE COMMENCEBARIO TO ANY WORK, ANY DISCOREPANCIES SHALL BE REPORTED TO THE SURVEY SERVICE ANY OR CALENDARY OF SHALL BE OF THE SURVEY BELLEVANT SERVICE ANY OR TO SURVEY SHALL ENSURE THAT A SWOOTH EVEN PROPILE, RREE FROM ARRUPT CHANGES IS ACHIEVED.

  THE CONTRACTOR SHALL ARPANGE ALL SURVEY SETOUT TO BE CARRIED OUT BY A REGISTERED SURVEYOR.

- CONTRACTOR TO OBTAIN AUTHORITY APPROVALS WHERE APPI
- ES. NO
  OR
  ABLE.
  DOD.
  LANDSCAPE,
  AWINGS AND WRITTEN INSTRUCTIONS THAT MAY BE ISSUED RELATING DEVELOPMENT AT THE SITE.
- ENCHES THROUGH EXISTING ROAD AND CONCRETE PAVEMEN WCUT TO FULL DEPTH OF CONCRETE AND A MINIMUM OF 50m UMINOUS PAVING.

S SHALL BE N

- BRICK S EXTENDING ALL BRANCH GAS AND WATER SERVICES UNDER DRIVEWAYS AND AAVING SHALL BELOCATED IN \$80 LIV/C SEWER GRADE CONDUITS A MINIMUM OF 500mm BEYOND EDGE OF PAVING.
  - ADE EVENLY R THAN Smm INT.
- ALL COVERS AND GRATES ETC TO EXISTING SERVICE UTILITIES. ADJUSTED TO SUIT NEW FINISHED SURFACE LEVELS WHERE AP

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Park Dy	Og Park Dig	C C Can Park To	is injow
	Woolw orths	Peter Brack Dr after Oran Park Dr	
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all		Peter Brock Dr	
PROPOSED SITE		Peter	
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apport	S Alidinia		
SAN	1 Add Duct	2:21 Unitos	
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### LOCALITY SKETCH

DRAWING SCHEDULE	1818B_DA_C000 COVER SHEET, DRAWING SCHEDULE, NOTES AND LOCALITY SKETCH	18188_DA_C100 GENERAL ARRANGEMENT PLAN	18188_DA_C101 DETAIL PLAN - GROUND FLOOR	18188_DA_C200 STORMWATER MISCELLANEOUS DETAILS AND PIT LID SCHEDULE	18188_DA_C201 OSD PLAN, SECTIONS AND DETAILS	18188_DA_C250 STORMWATER CATCHMENT PLAN	18188 DA_SE01 SEDIMENT AND EROSION CONTROL PLAN	10100 DA CENS
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# Approved by the Council of Camden under the provisions of the Environment Planning and Assessment Act 1979 APPROVAL

## **DEVELOPMENT APPLICATION**

DA 2018/710/1

# DRAINAGE NOTES: 3. ALL STORMWATER WORK TO COMPLY WITH AS \$500 PART 3

- 2. CONTRACTOR SHALL BE RESPONSIBLE FOR MAINTAINING THE MINIMUM COVER OF 600mm ON ALL PIPES PROTECTION OF PIPES DUE TO LOADS EXCEEDING W/WHEEL LOAD SHALL BE THE CONTRACTORS FESPONSIBILITY.
- 8. BEDDING TYPE SHALL BE TYPE HZ FOR RCP. WHERE NECESSARY THE OVERLAY ZONE SHALL BE REDUCED TO ACCOMMODATE PAVEMENT REQUIREMENTS. REFER TO THIS DRAWING FOR DETAILS. 5. MINIMUM COVER OVER EXISTING PIPES FOR PROTECTION DURING CONSTRUCTION SHALL BE 800min

  - 3. NO CONSTRUCTION LOADS SHALL BE APPLIED TO PLASTIC PIPES.
  - FINISHED SURFACE LEVELS SHOWN ON LAYOUT PLAN DRGS TAKE PRECEDENCE OVER DESIGN DRAINAG URFACE LEVELS.
- A ALL PRES UP TO AND INCLUDING 300 DIA SHALL BE SQUENT OR RUBBER RINA JOINTED PUC GLASS SHIPPE TO RISE OF THE THOR SHIPPE TO THE HIPPETS TO BE REPO SHOWN CLASS STRUBBER RINA JOINTED PIPE HARDIES FRO PIPEMAY BE USEIN ULED OF ROTE PESHEDI IN GROUND, ALL AFRAIL PIPET TO BE PVO CLASS SH.
- 9. ALL PITS IN NON TRAFFICABLE, AREAS TO BE PREFABRICATED POLVESTER CONCRETE. "POLVCRETE" WITH "LIGHT TOWN CLASS BOALV, MAN SOTER GRAPINA AND PRAME."
  ALL PITS IN TRAFFICABLE AREAS (CLASS DY LOADING MAY) TO HAME 150mm THOK CONCRETE WALLS AND BASE TAILS IN TISTANT PREFABLE CLASS DY LOADING MAY) TO HAME 150mm THOK CONCRETE WALLS AND BASE CHEN SITUL PLACE LOADING PREFABRATE TO SET INSTITUTE AND THAT HOW TO AND THAT TO SET ONLY MAIL OF SET CALL VALUE OF SET AND AND STELL GRATING AND PRAME TO SET IT DESIGN LOADING PRECAST PROFESSOR PORAMINESSE THAT SET, CALL VALUE STELL GRATING AND SHALL COMPLY WITH RELEVANT AUSTRALIAN.
  - 10. ALL PITS, GRATINGS AND FRAMES SHALL BE INSTALLED IN ACCORDANCE WITH THE MANUFACTURENS SPECFICATION AND TO BE IN ACCORDANCE WITH ASSOCIA AND ASSOR.

    PRESIDENT OF THE PROPERTY OF SECULATION OF SECULATION OF THE POLLOWING.

- 13. GALVANISED STEP IRONS SHALL BE PROVIDED AT 300 CTS FOR PITS HAVING A DEPTH EXCEEDING 1200mm. SUBSOIL DRAINAGE PIPE SHALL BE PROVIDED IN PIPE TRENCHES ADJACENT TO INLET PIPES, (MINMAIMLENGTH 3m) 12. FOR PIPE SIZES GREATER THAN Ø300mm, PIT FLOOR IS TO BE BENCHED TO FACILITATE FLOW
  - 14 ALL SUBSOL, PIPES SHALL BE 100mm SLOTTED PVC IN A FILTER SOCK, UNO, WITH 3m INSTALLED UPSTREAM OF 15. ALL PIPEWORK SHALL HAVE MINIMUM DIAMETER 100.
    - 16. MINIMUM GRADE FOR ROOPWATER DRAINAGE LINES SHALL BE 1%
- 17. ALL PIPE JUNCTIONS AND TAPER UP TO AND INCLUDING 300 DIA. SHALL BE VIA PURPOSE MADE FITTINGS
  - 18. ALL ROOF DRAINAGE TO BE INSTALLED IN ACCORDANCE WITH AS3500, PART 3. TESTING TO BE UNDERT AND REPORTS PROVIDED TO THE SUPERINTENDENT.
- IX DIT'N RIZKESS OF 1.5 in DEEP TO HAVE WILL AND FLOOR THICKNESS INCREASED TO 200mm RENN-PACED WITT TRANSO OTS CENTRALLY A LACED DOTH WAYS THROUGHOUT UAK ON SEPARATE DESIGN DRAWNOS IN THIS SET TREPTHE DOZEGOS IN CONTACT ROBINERS. 9. LOCATION OF THE DIRECT DOWN PIPE CONNECTIONS MAY VARY ON SITE TO SUIT SITE CONDITIONS, WHERE CONNECTION SHOWN ON LONG SECTIONS CHAINAGES ARE INDICATIVE ONLY.

  - 21. SUBSOIL DRAINAGE LINES FOR LANDSCAPE AREA NOT SHOWN ON THESE DRAWINGS, REFER TO LANDSCAPING PLANS FOR DETAILS. 22. ALL STORMMATER PITS TO HAVE Ø100 LØVC SLOTTED SUBSOIL PIPES CONNECTED TO THEM. THESE SUBSOILS TO EXTEND 3m UPSTREAM OF THE PIT AT A MAINIMAM GRADE.

### SURVEY NOTES

THE INFORMATION IS SHOWN TO PROVIDE A BASIS FOR DESIGN. HENRY AND HYMOS PROFILED SON GUIGABATHE THE ACCIOURACY OR COMPILETIVED SON THE SURVEY BESE ON RTS. SUTRABILITY AS A BASIS FOR CONSTITUCION DORANINES.
SHOULD DISCREPANCES BE ENCOUNTERED DURING CONSTRUCTION BETWEEN THE SIRKEY DATA AND ACTUAL HELD DATA, CONTACT HENRY AND HYMAS PTY, LID THE FCLLOWING NOTES HAVE BEEN TAKEN DIRECTLY FROM ORIGINAL SURVEY DOCUMENTS. THE EXISTING SITE CONDITIONS SHOWN ON THE FOLLOWING DRAWING HAVE BEEN INVESTIGATED BY THE SURVEYOR SPECIFIED IN THE TITLE

## FOR DA ONLY

PROPOSED RESIDENTIAL BLILL DING	Drawi M.Cerna	Designed J.Gormly	Date APR 18	
ORAN PARK DRIVE, ORAN PARK, NSW	Checked A.Francis	Approved A.Francis	Scale	
COVER SHEET, DRAWING SCHEDULE, NOTES AND LOCALITY SKETCH	18188	18188_DA_C000 03	00	03

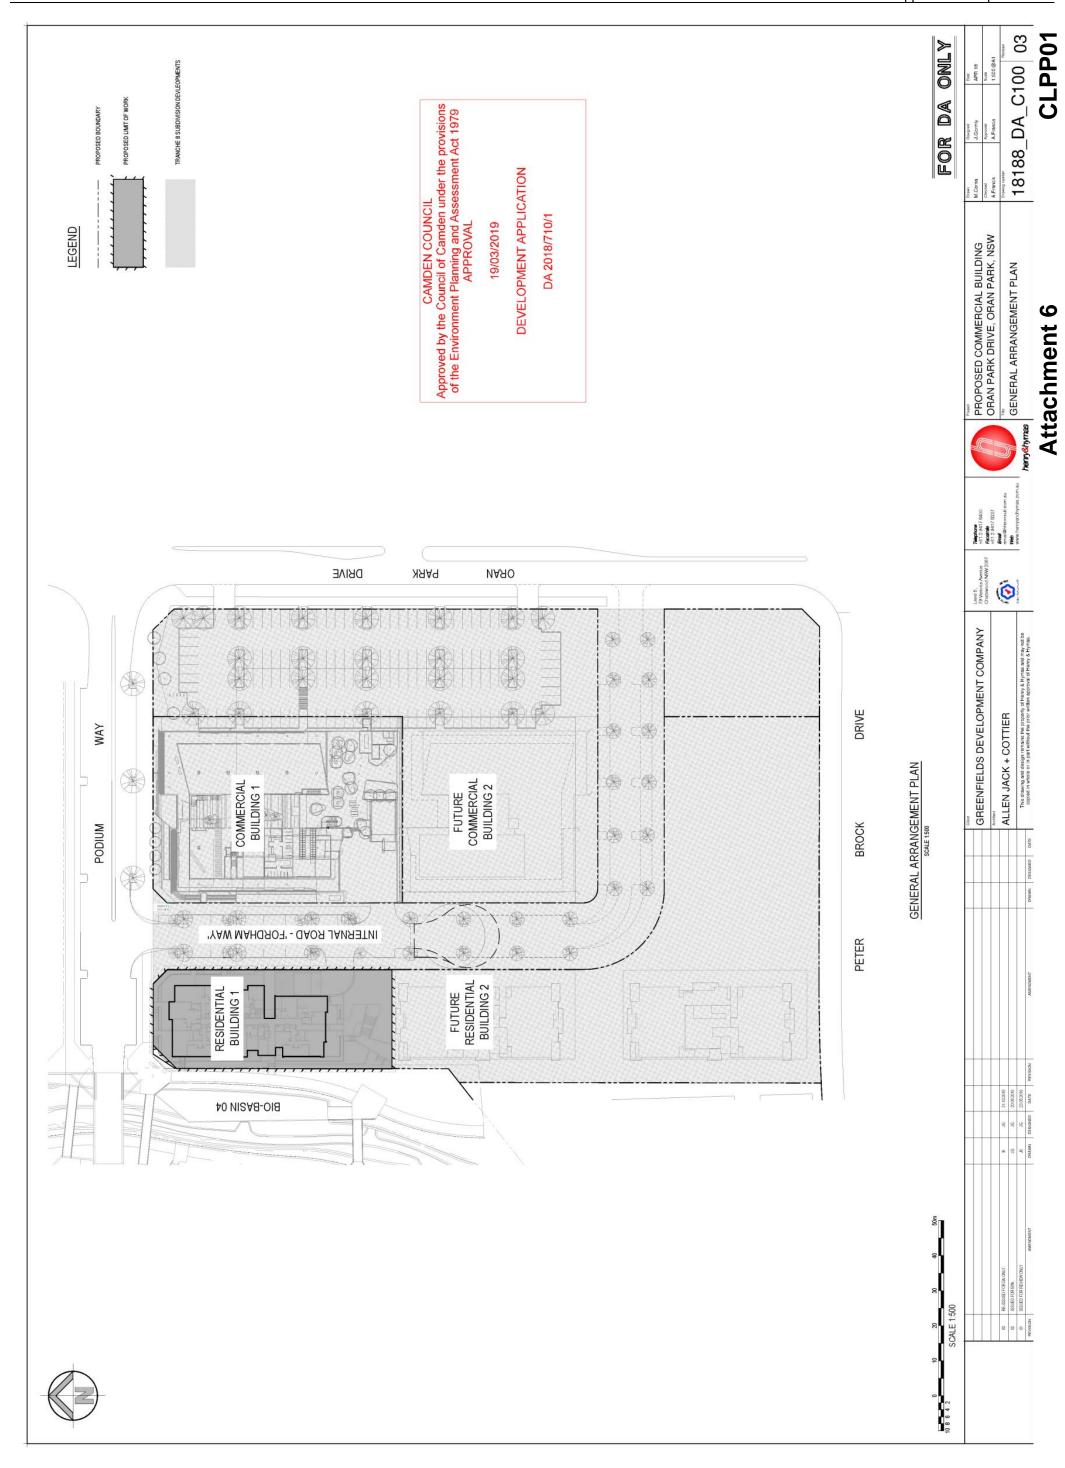
Telephone
+61.2.9417.8400
Faceinite
+61.2.9417.8337
Erral
erral@hrpcorsult.pop

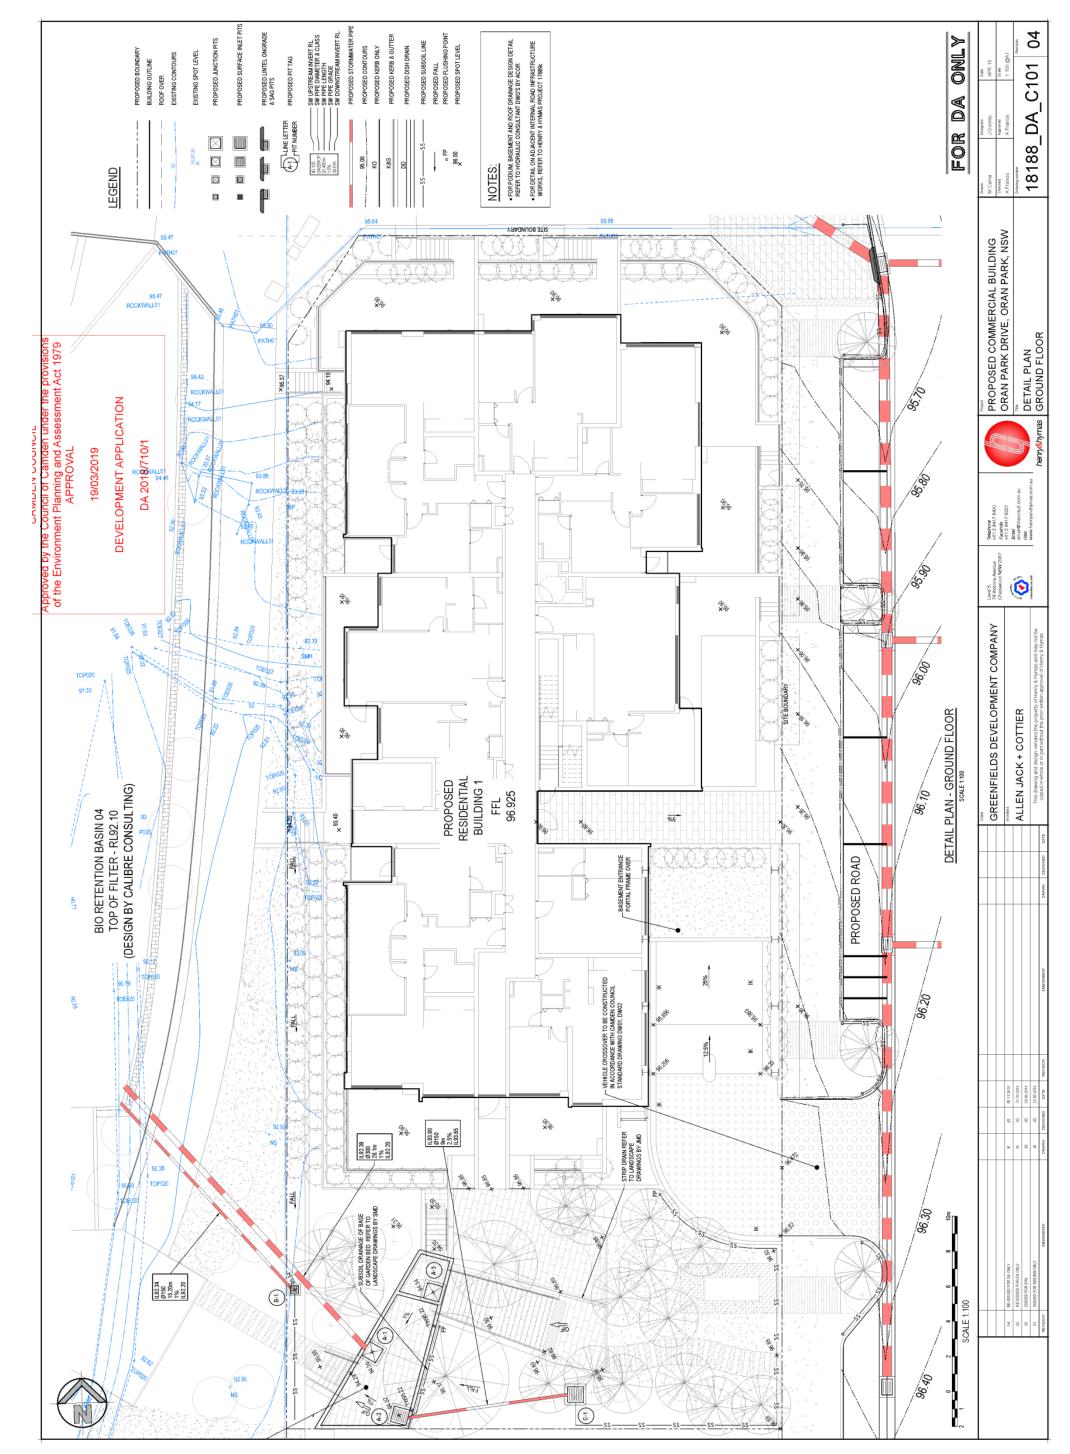
Level 5, 79 Vintoria Avenue Chatswood NSW 2067 (0)

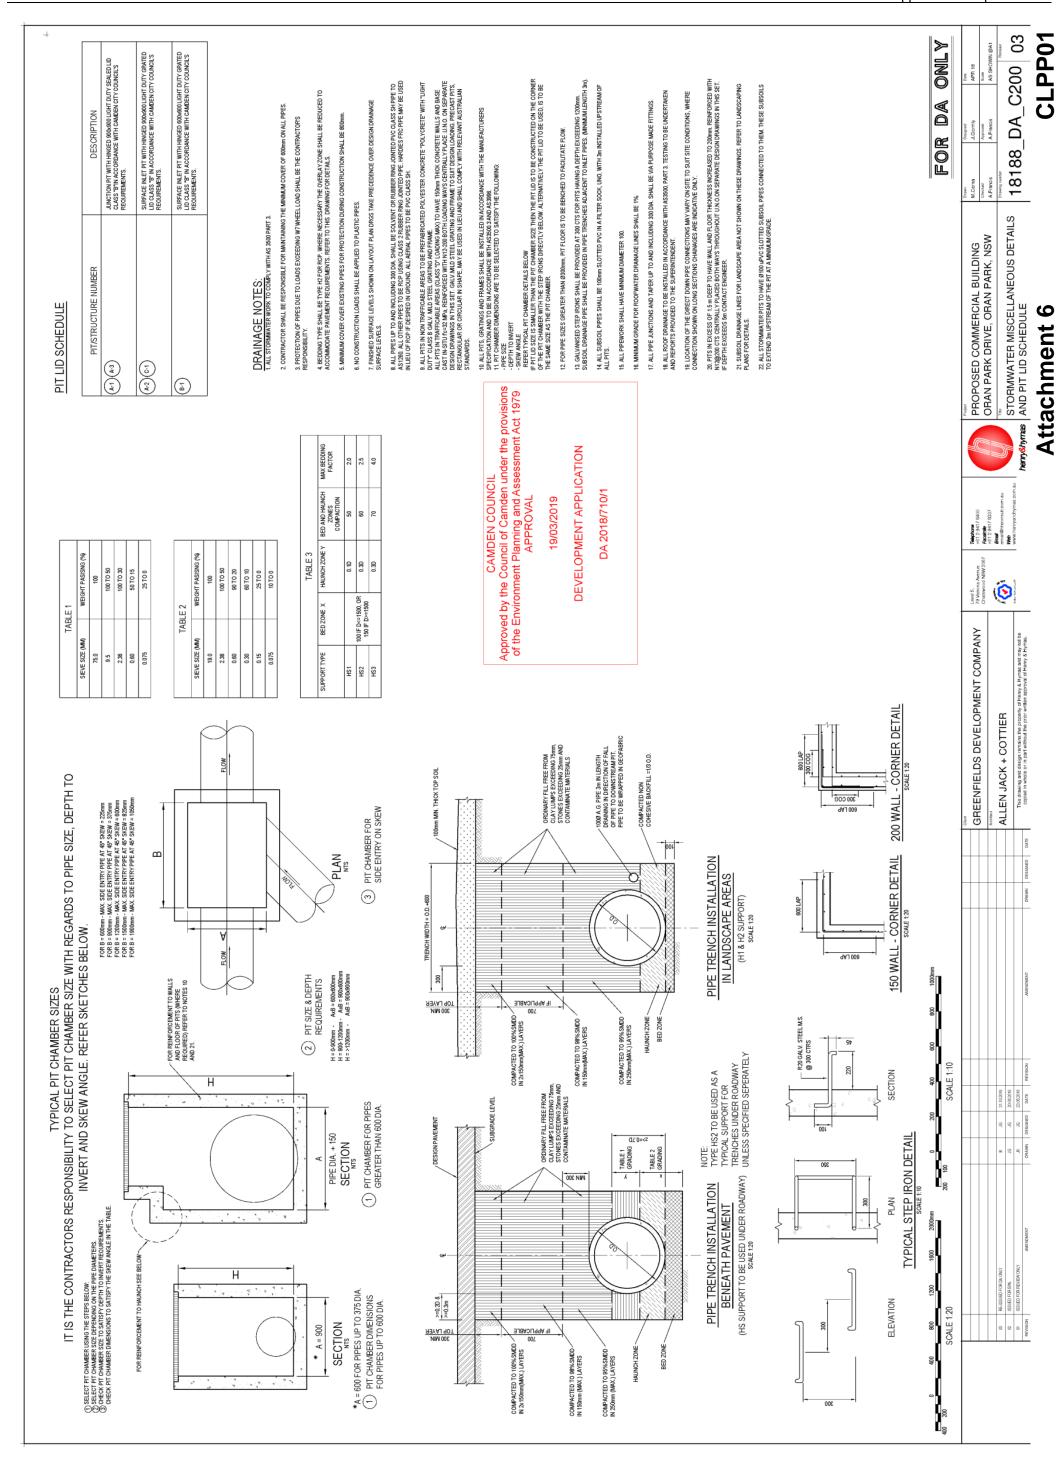
GREENFIELDS DEVELOPMENT COMPANY

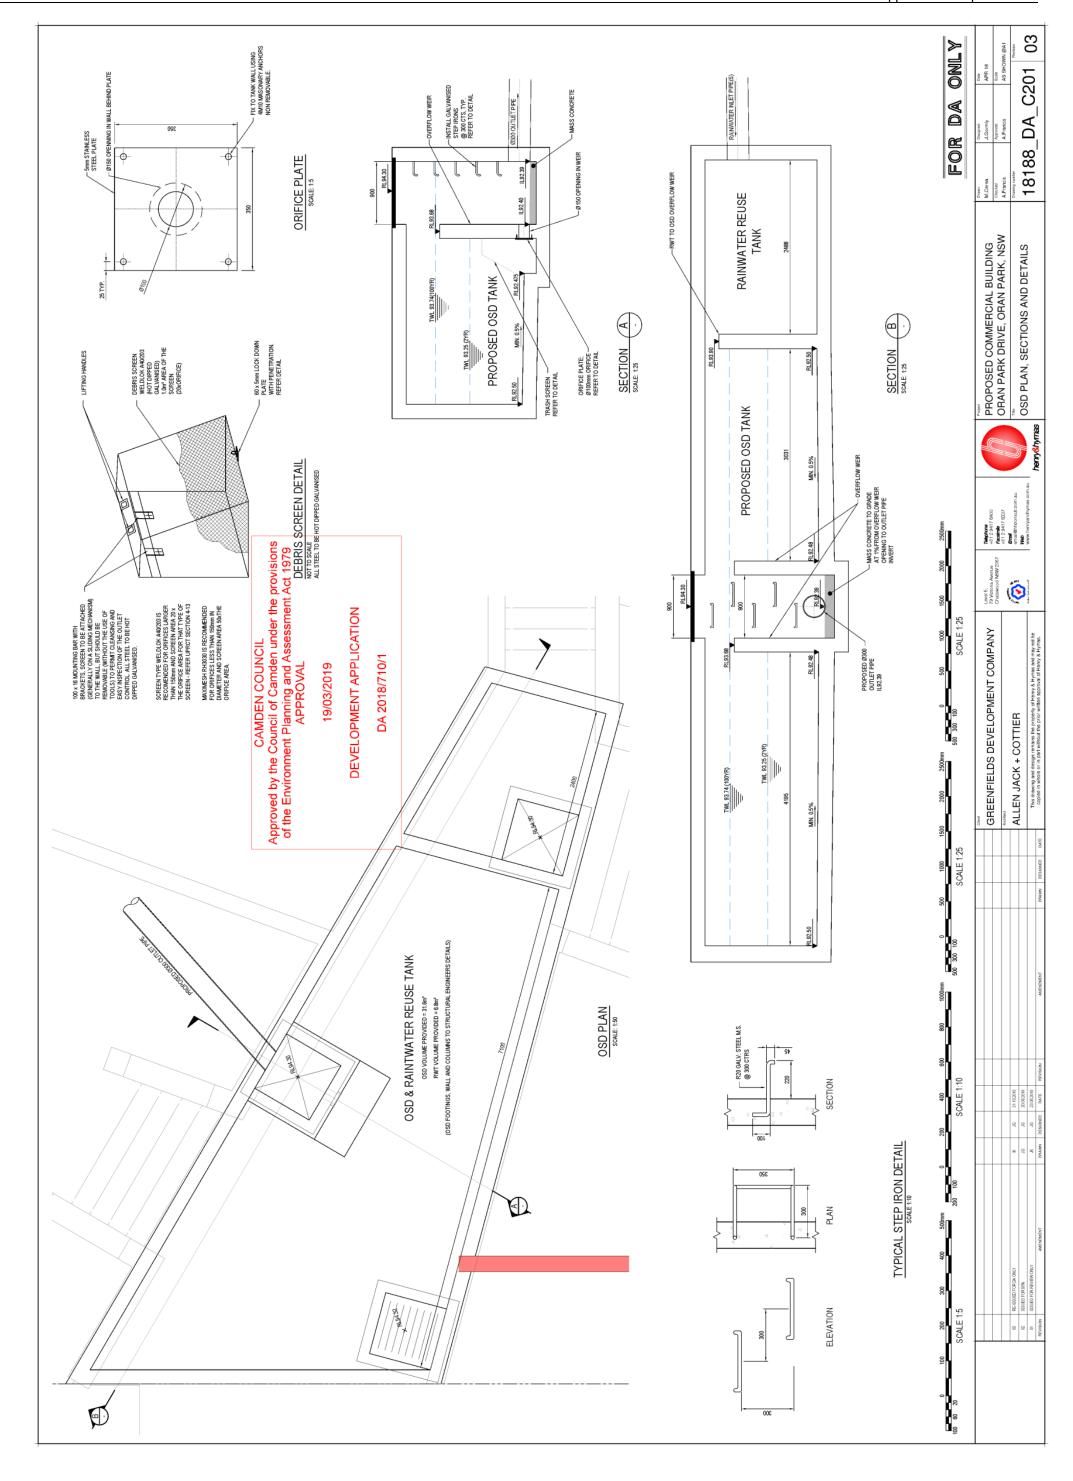
ALLEN JACK + COTTIER

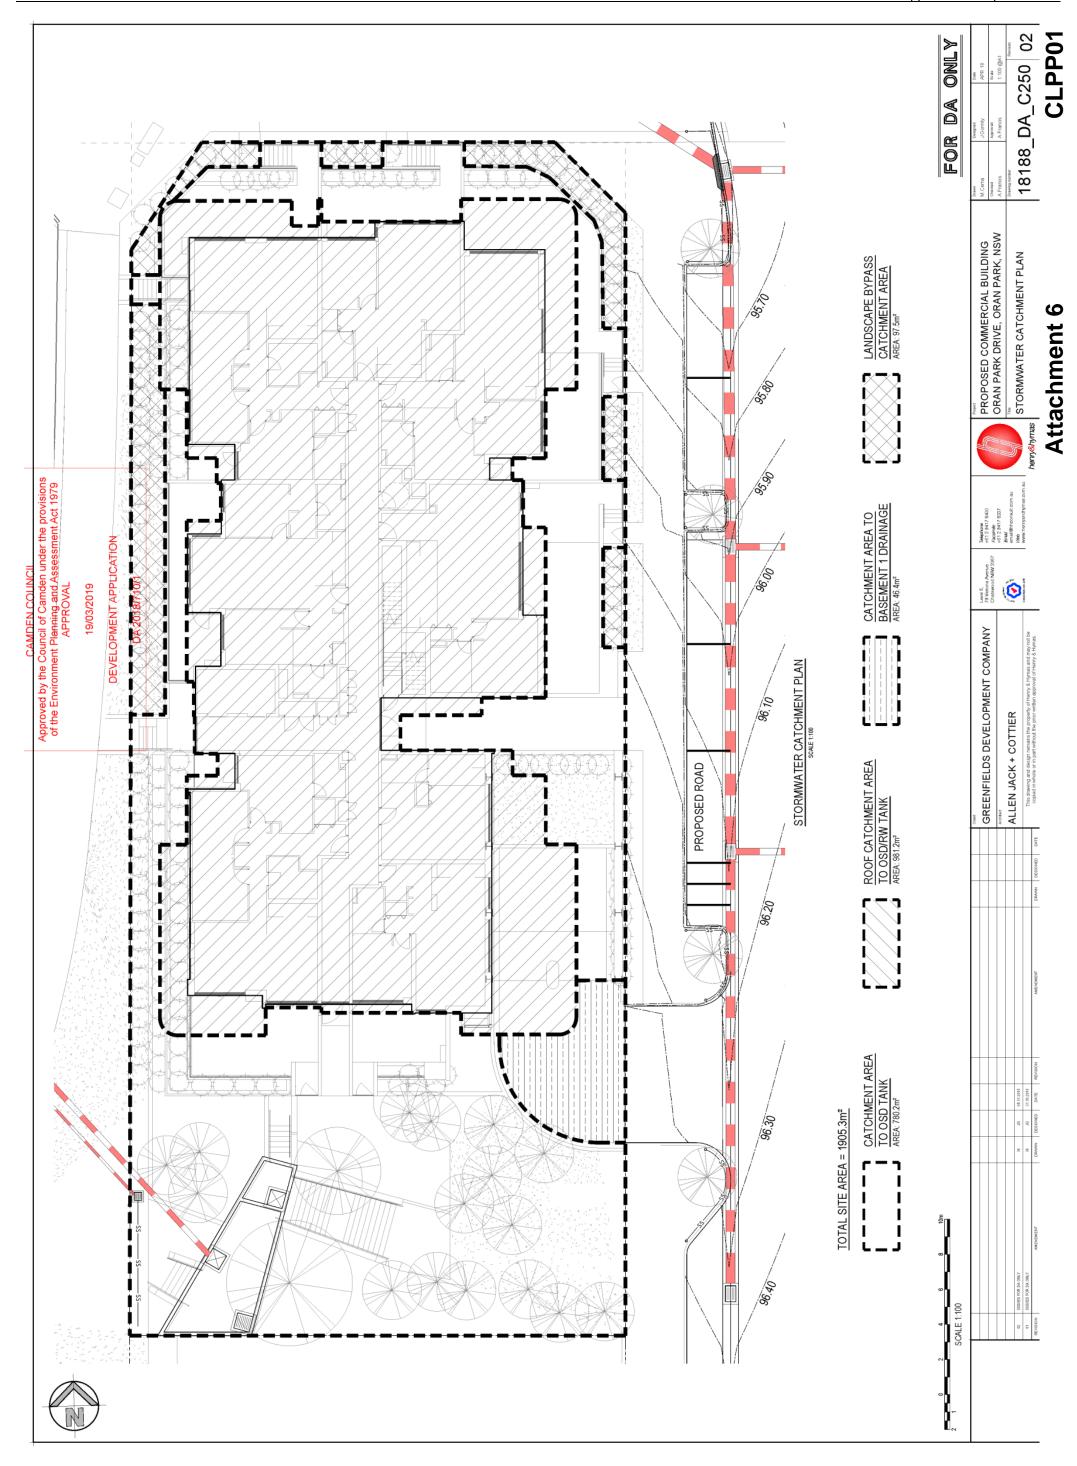
Drawn	Designed	Date	
M.Cerna	J.Garmly	APR 18	
Checked	Approved	Scale	
A.Francis	A.Francis	STN	
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18188	DA	COOC	0
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Attachment 6

